

City of Fitchburg Planning/Zoning Department 5520 Lacy Road Fitchburg, WI 53711 (608-270-4200)

# ARCHITECTURAL & DESIGN REVIEW APPLICATION

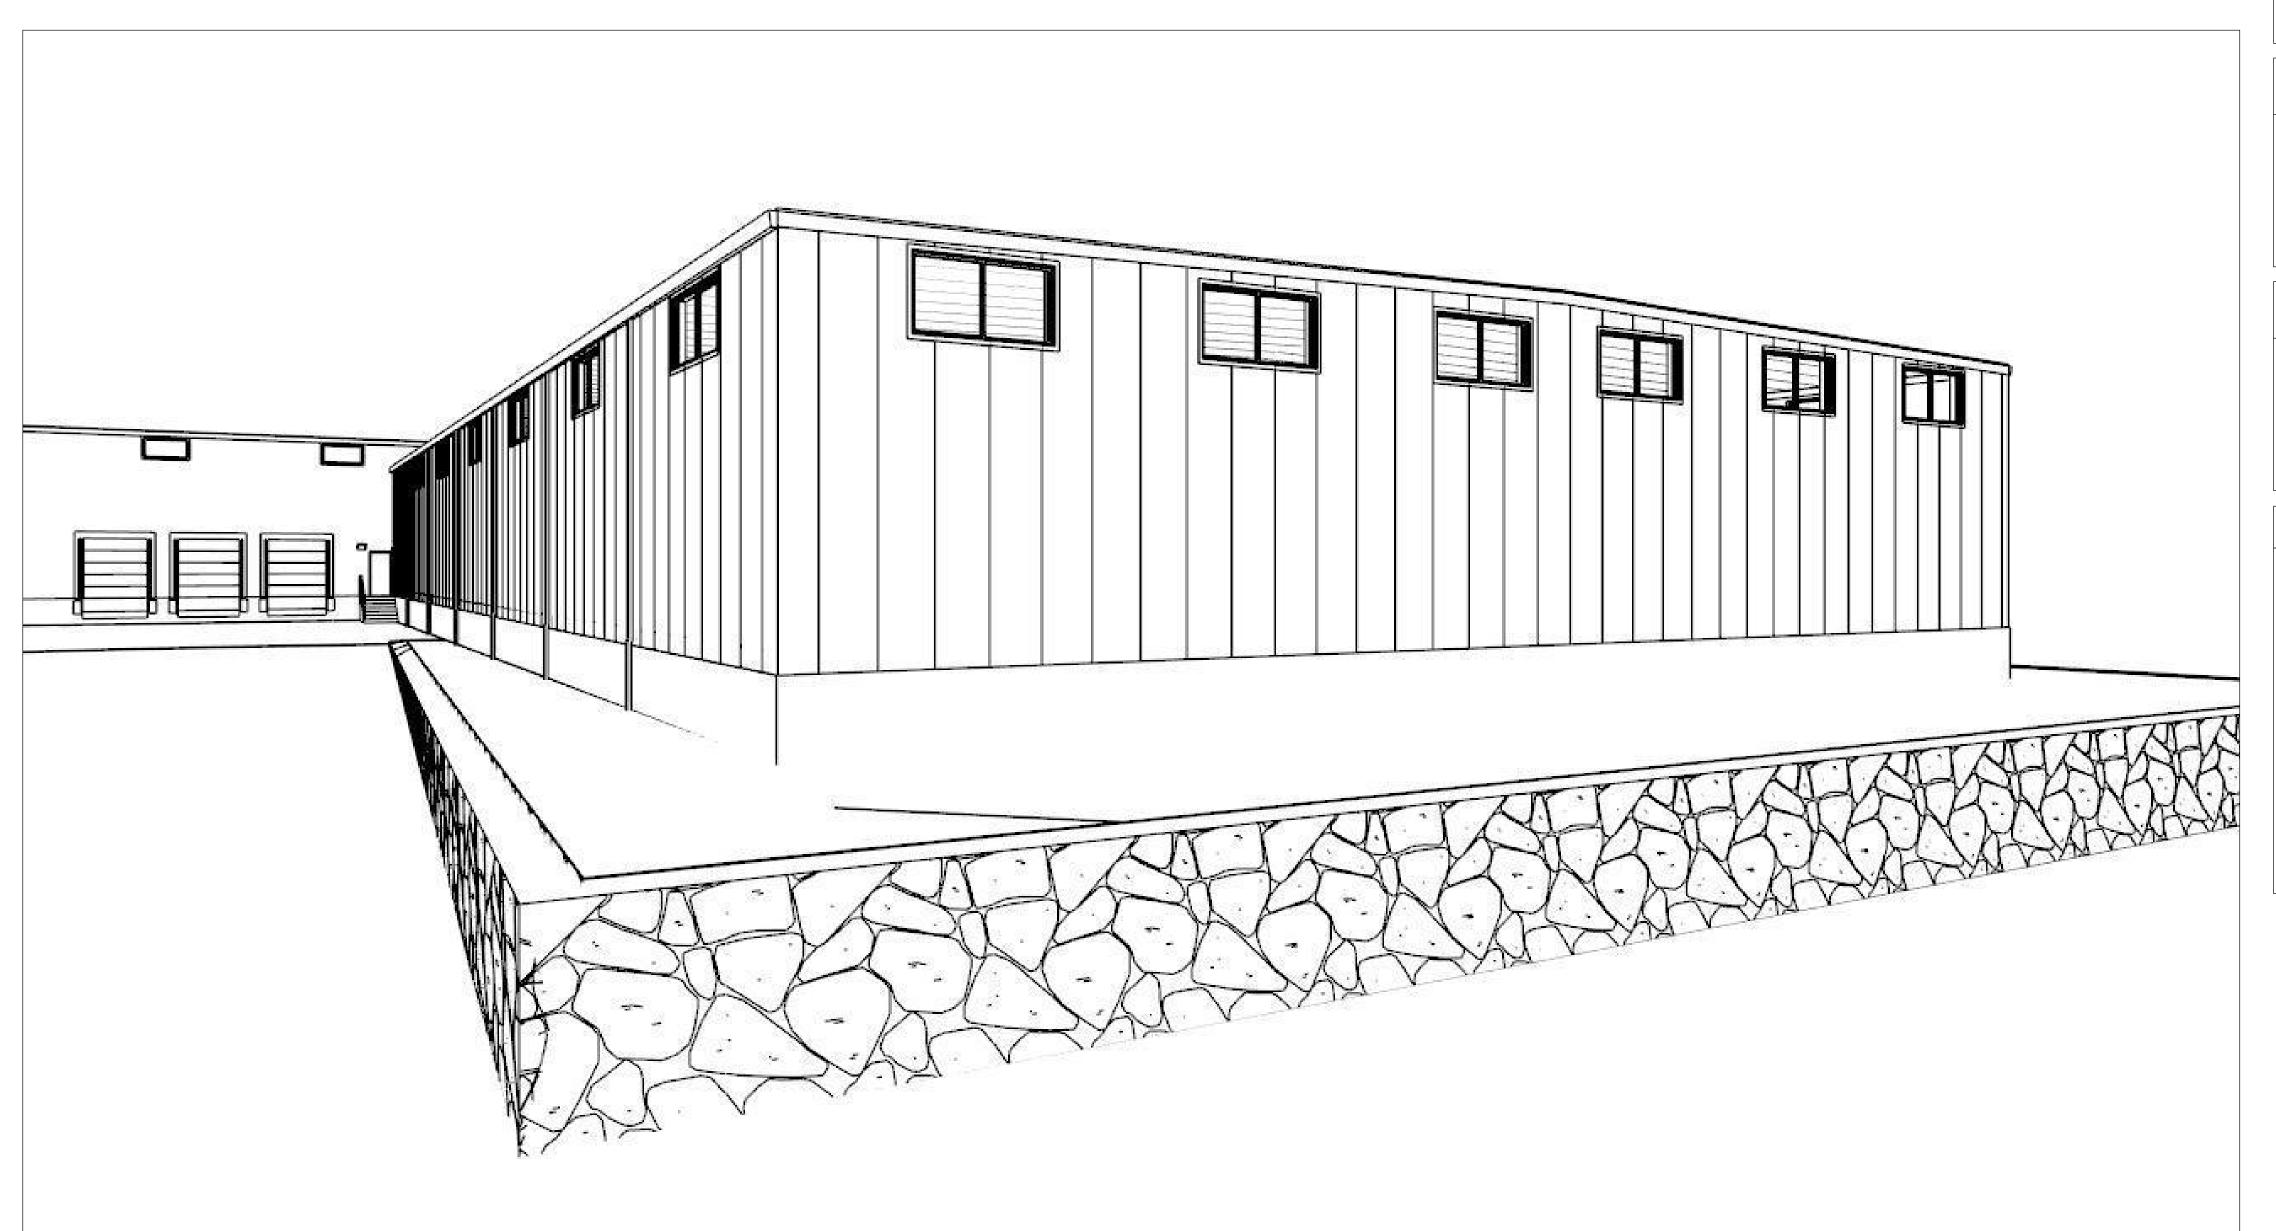
Applicant/Contact Person: Dames Span
Address: 6880 CTH M Phone Number of Contact Person: 608-235-64
City, State, Zip Code: Verova, WI 53583 Email of Contact Person: AUSPAHR G Charles.
Project Address: 5253 Verous Road Lot: Subdivision:
Project Type: Multi-Family Commercial Industrial Other
New Addition
Impervious Surface Ratio (ISR): (City Standard: maximum 65% ISR)
All items listed below must be included with the application to be considered complete. If an item is not included with the application, the applicant must provide in writing the basis for not including it. Building and site plans submitted to the Fitchburg Plan Commission for architectural and design review shall contain the following information:
1. Lot or property dimensions. 2. Orientation (to north). 3. Adjacent highways, roads, drive, etc. 4. Existing natural features (rivers, ponds, wetlands). 5. Existing buildings and/or improvements. 6. Existing and proposed site drainage. 7. Utility plans, including main/lateral sizes and existing fire hydrants on site or within 300 feet of the site 8. ISR shall be indicated on all plans. 9. Stormwater management plans and details. 10. Lighting plan in footcandles and light fixture cut sheets.
1. Building size, configuration and orientation. 2. Distance from lot lines. 3. Distance from other buildings, improvements and natural features. 4. Location of well, septic tank, drainfield, etc. (if applicable) 5. Additional proposed additions or new structures. 6. Construction type (wood frame, structural steel, etc.). 7. Foundation type (full basement, slab on grade, etc.). 8. Number of levels. 9. Siding/exterior covering type, color, texture, etc. 10. Roof type (gable, hip, shed, flat, etc.) and pitch. 11. Roofing material type, color, texture, etc. 12. Exterior door and window location, size, type, etc. 13. Fire protection sprinklers or fire alarm systems.
Ingress, Egress, Parking:  1. Location of highway and road access points. 2. Location, size, configuration of drivers and walks. 3. Number, size, location of parking spaces. 4. Location of handicapped parking and accessible building entrances. 5. Bicycle rack(s).

# ARCHITECTURAL AND DESIGN REVIEW APPLICATION Page 2

Landscaping:  1. Location, species, size of existing trees, shrubs, and plantings. 2. Location, species, size of proposed plantings. 3. Location and size of all paved, seeded/sodded and gravelled areas. 4. Location of all retaining walls, fences, berms and other landscape features.
'It is highly recommended that an applicant hold at least one neighborhood meeting prior to submitting an ADR application to identify any concerns or issues of surrounding residents.
The preceding information is considered to be the minimum information for submission, and the City may require additional information for its review. Any interpretations provided by city officials as the result of submitting the attached information are based on the submitted plans, and any plan changes, may affect the interpretations.
signed applicant acknowledges the above information and hereby submits the attached information for the City's Architectural and Design Review Flocess.  Signed: Date: 9/23/15  Applicant or Authorized Agent
*** Application shall be accombanied by one (1) sets of full-size plans, two (2) sets no larger than 11"x17", and one (1) pdf document of the complete submittal to <a href="mailto:planning@fitchburgwi.gov">planning@fitchburgwi.gov</a> . Applications are due at least 4 weeks prior to the desired Plan Commission Meeting. The time frame assumes a complete set of plans is provided, and if it is not provided the Plan Commission date will be adjusted.
FOR CITY USE ONLY
Date Received: 9 22 2015 Plan Commission Date:
Comments:

# esign hitectura

# Addition to Saris Cycling Group for Lionshare Group, LLC



## **General Contractor**

Lionshare Group, LLC

5396 King James Way, Suite 220 Madison, WI 53719 608-217-9193 contact: James Spahr, Broker

# Metal Building Designer

**Varco Pruden Buildings** 

3200 Players Club Circle Memphis, TN 38125 901-748-8000 contact: Tom Lienhardt, District Manager

# **Architect**

Bouril Design Studio, LLC

6425 Odana Road, Suite 2 Madison, WI 53719 608-833-3400 contact: Robert Lackore, Project Manager

# Civil Engineers

Myser Engineering, LLC

201 1/2 East Maint Street Mount Horeb, WI 53572 608-843-3638

contact: Dan Schneider, Principal & Senior Project Engineer

# Stormwater Management

Montgomery Associates Resource Solutions, LLC

119 South Main Street Cottage Grove, WI 53527 608-839-4422

contact: Deborah Hatfield

### drawing sheet index

C100 Site Plan

C101 Park Lot Plan C200 Grading & Erosion Control Plan

L100 Landscape Plan

A1 Title Page

Lot Layout Plan A3 Foundation Plan

A4 Slab Plan

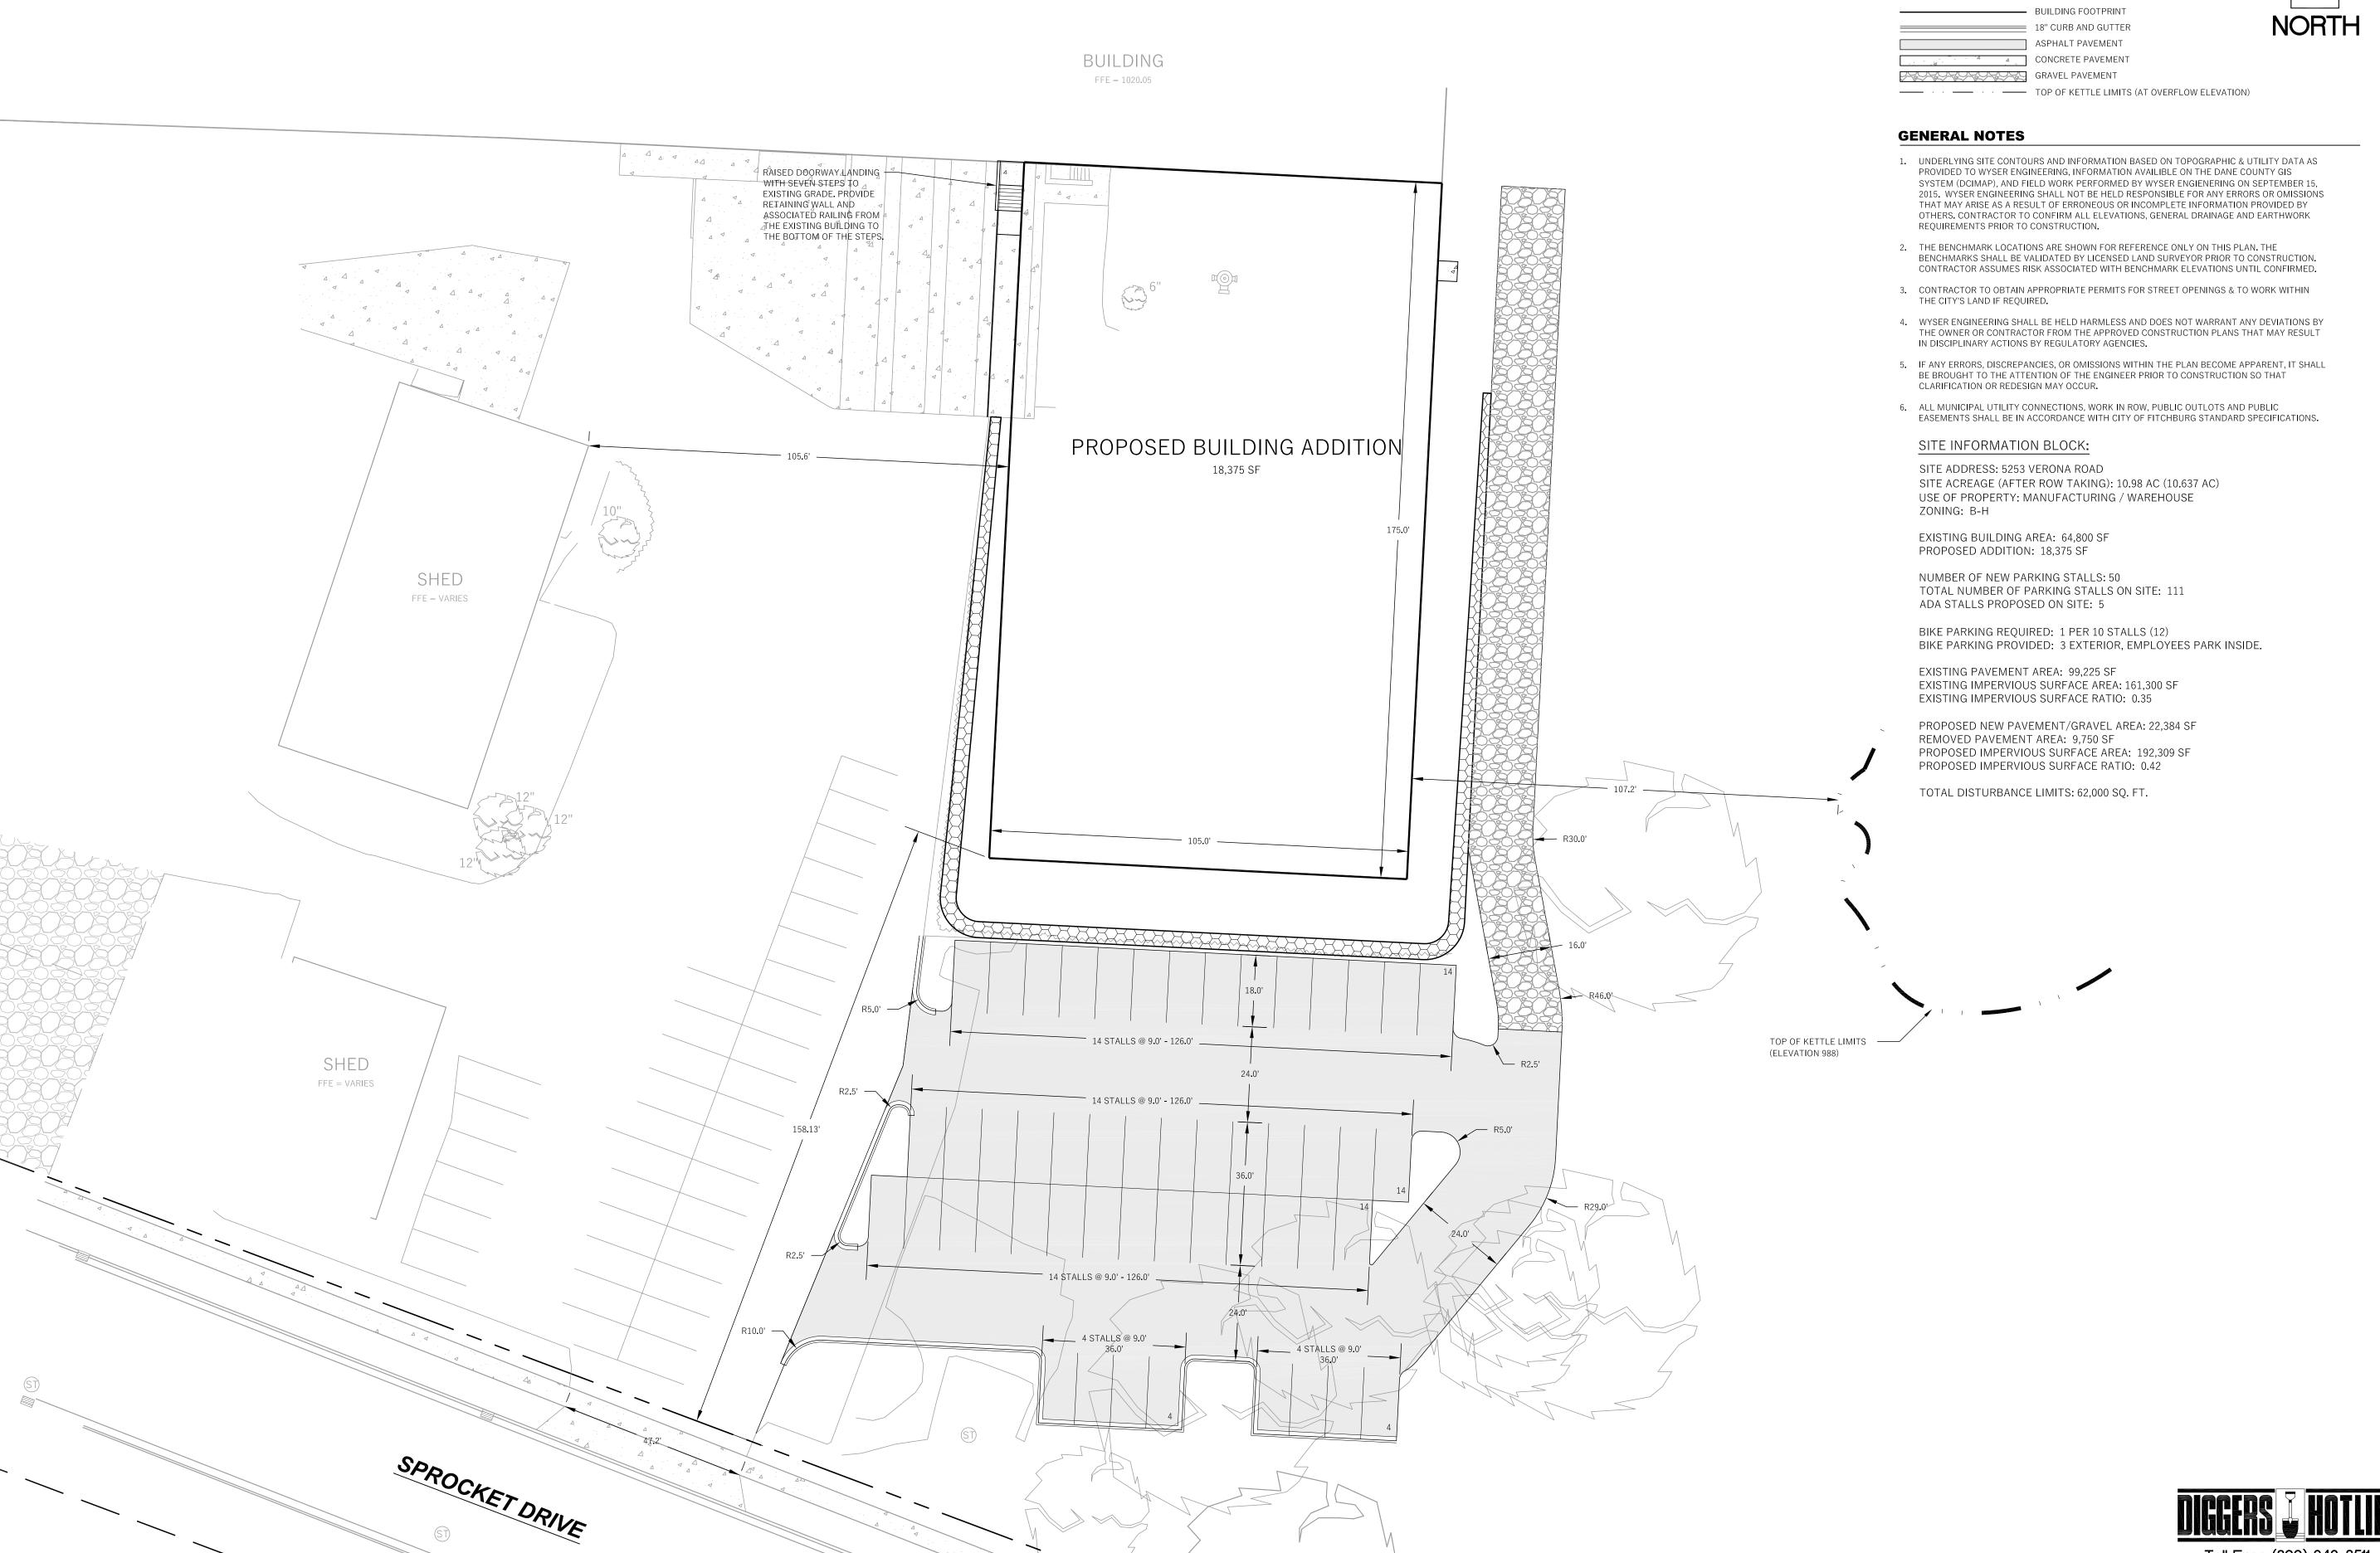
A5 Foundation Details Foundation Details

A7 Floor Plan

A9 Egress Plan

A8 Roof Plan A10 Exterior Elevations







	PROPOSED PROPERTY BOUNDARY	_
· ·	EASEMENT	
	BUILDING FOOTPRINT	
	18" CURB AND GUTTER	N
	ASPHALT PAVEMENT	
	CONCRETE PAVEMENT	
	GRAVEL PAVEMENT	




SARIS Revisions: Date: Description:

Number 14-0192 SCHEMATIC

09/18/2015

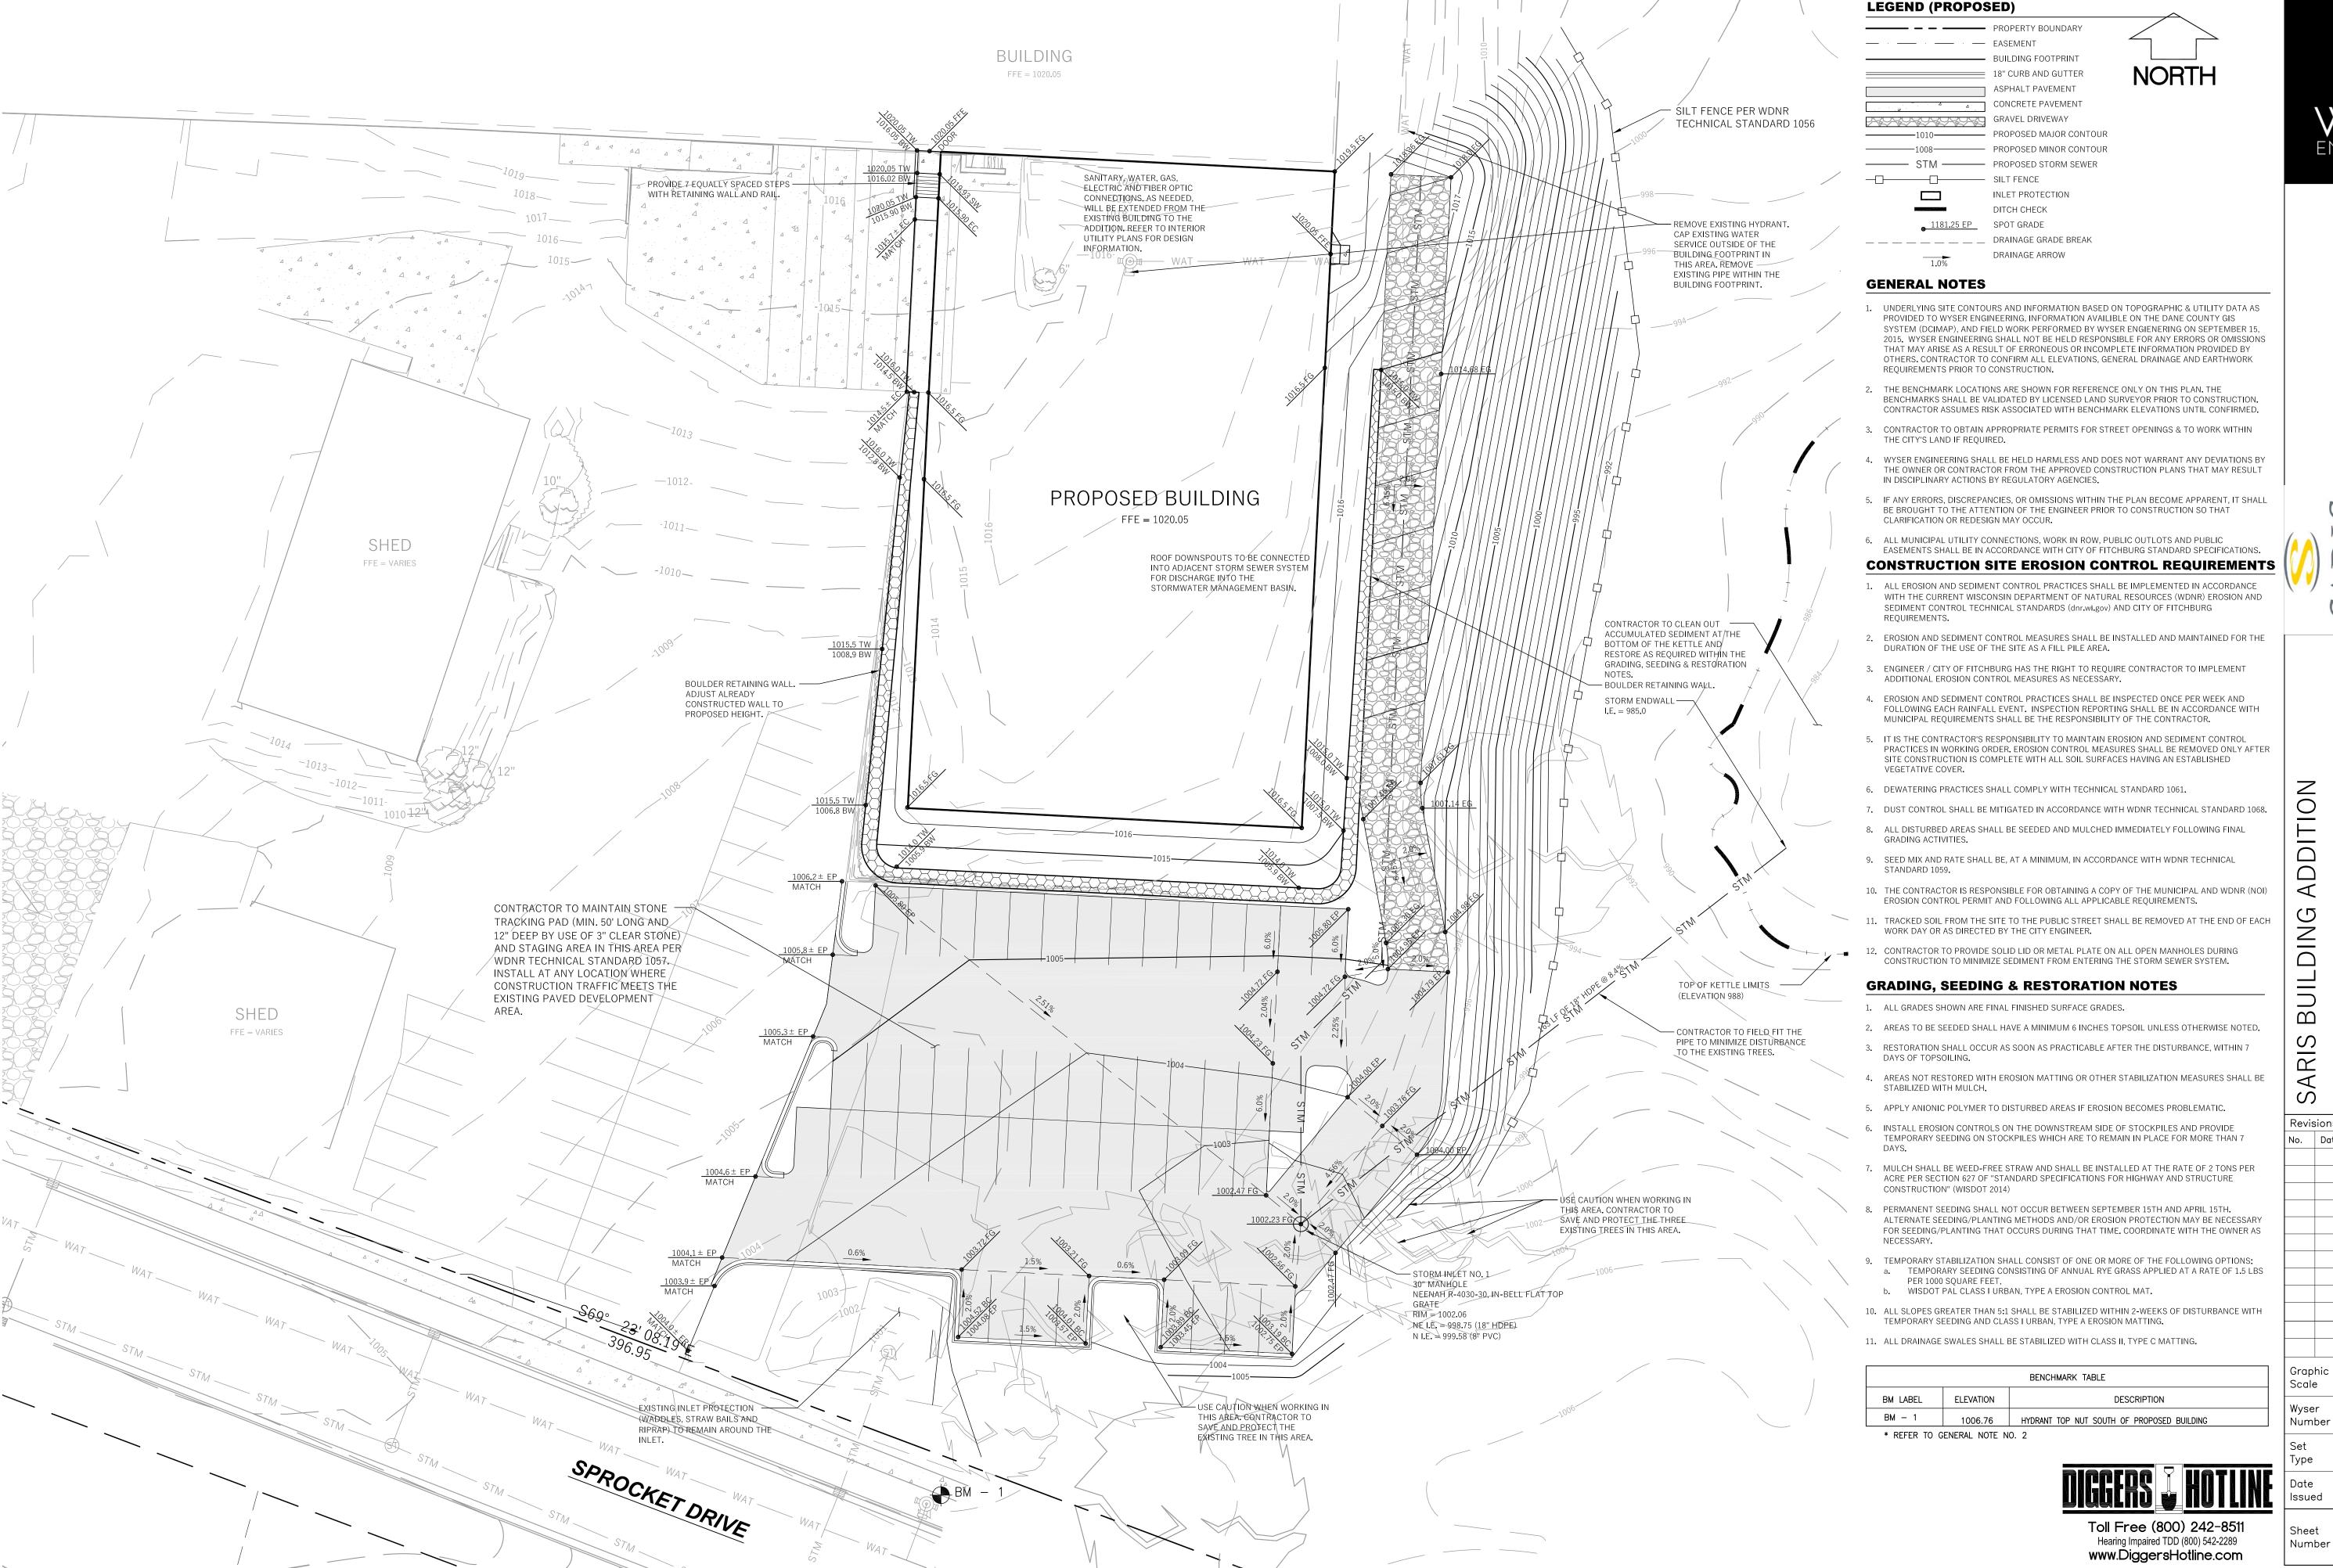Sheet Number

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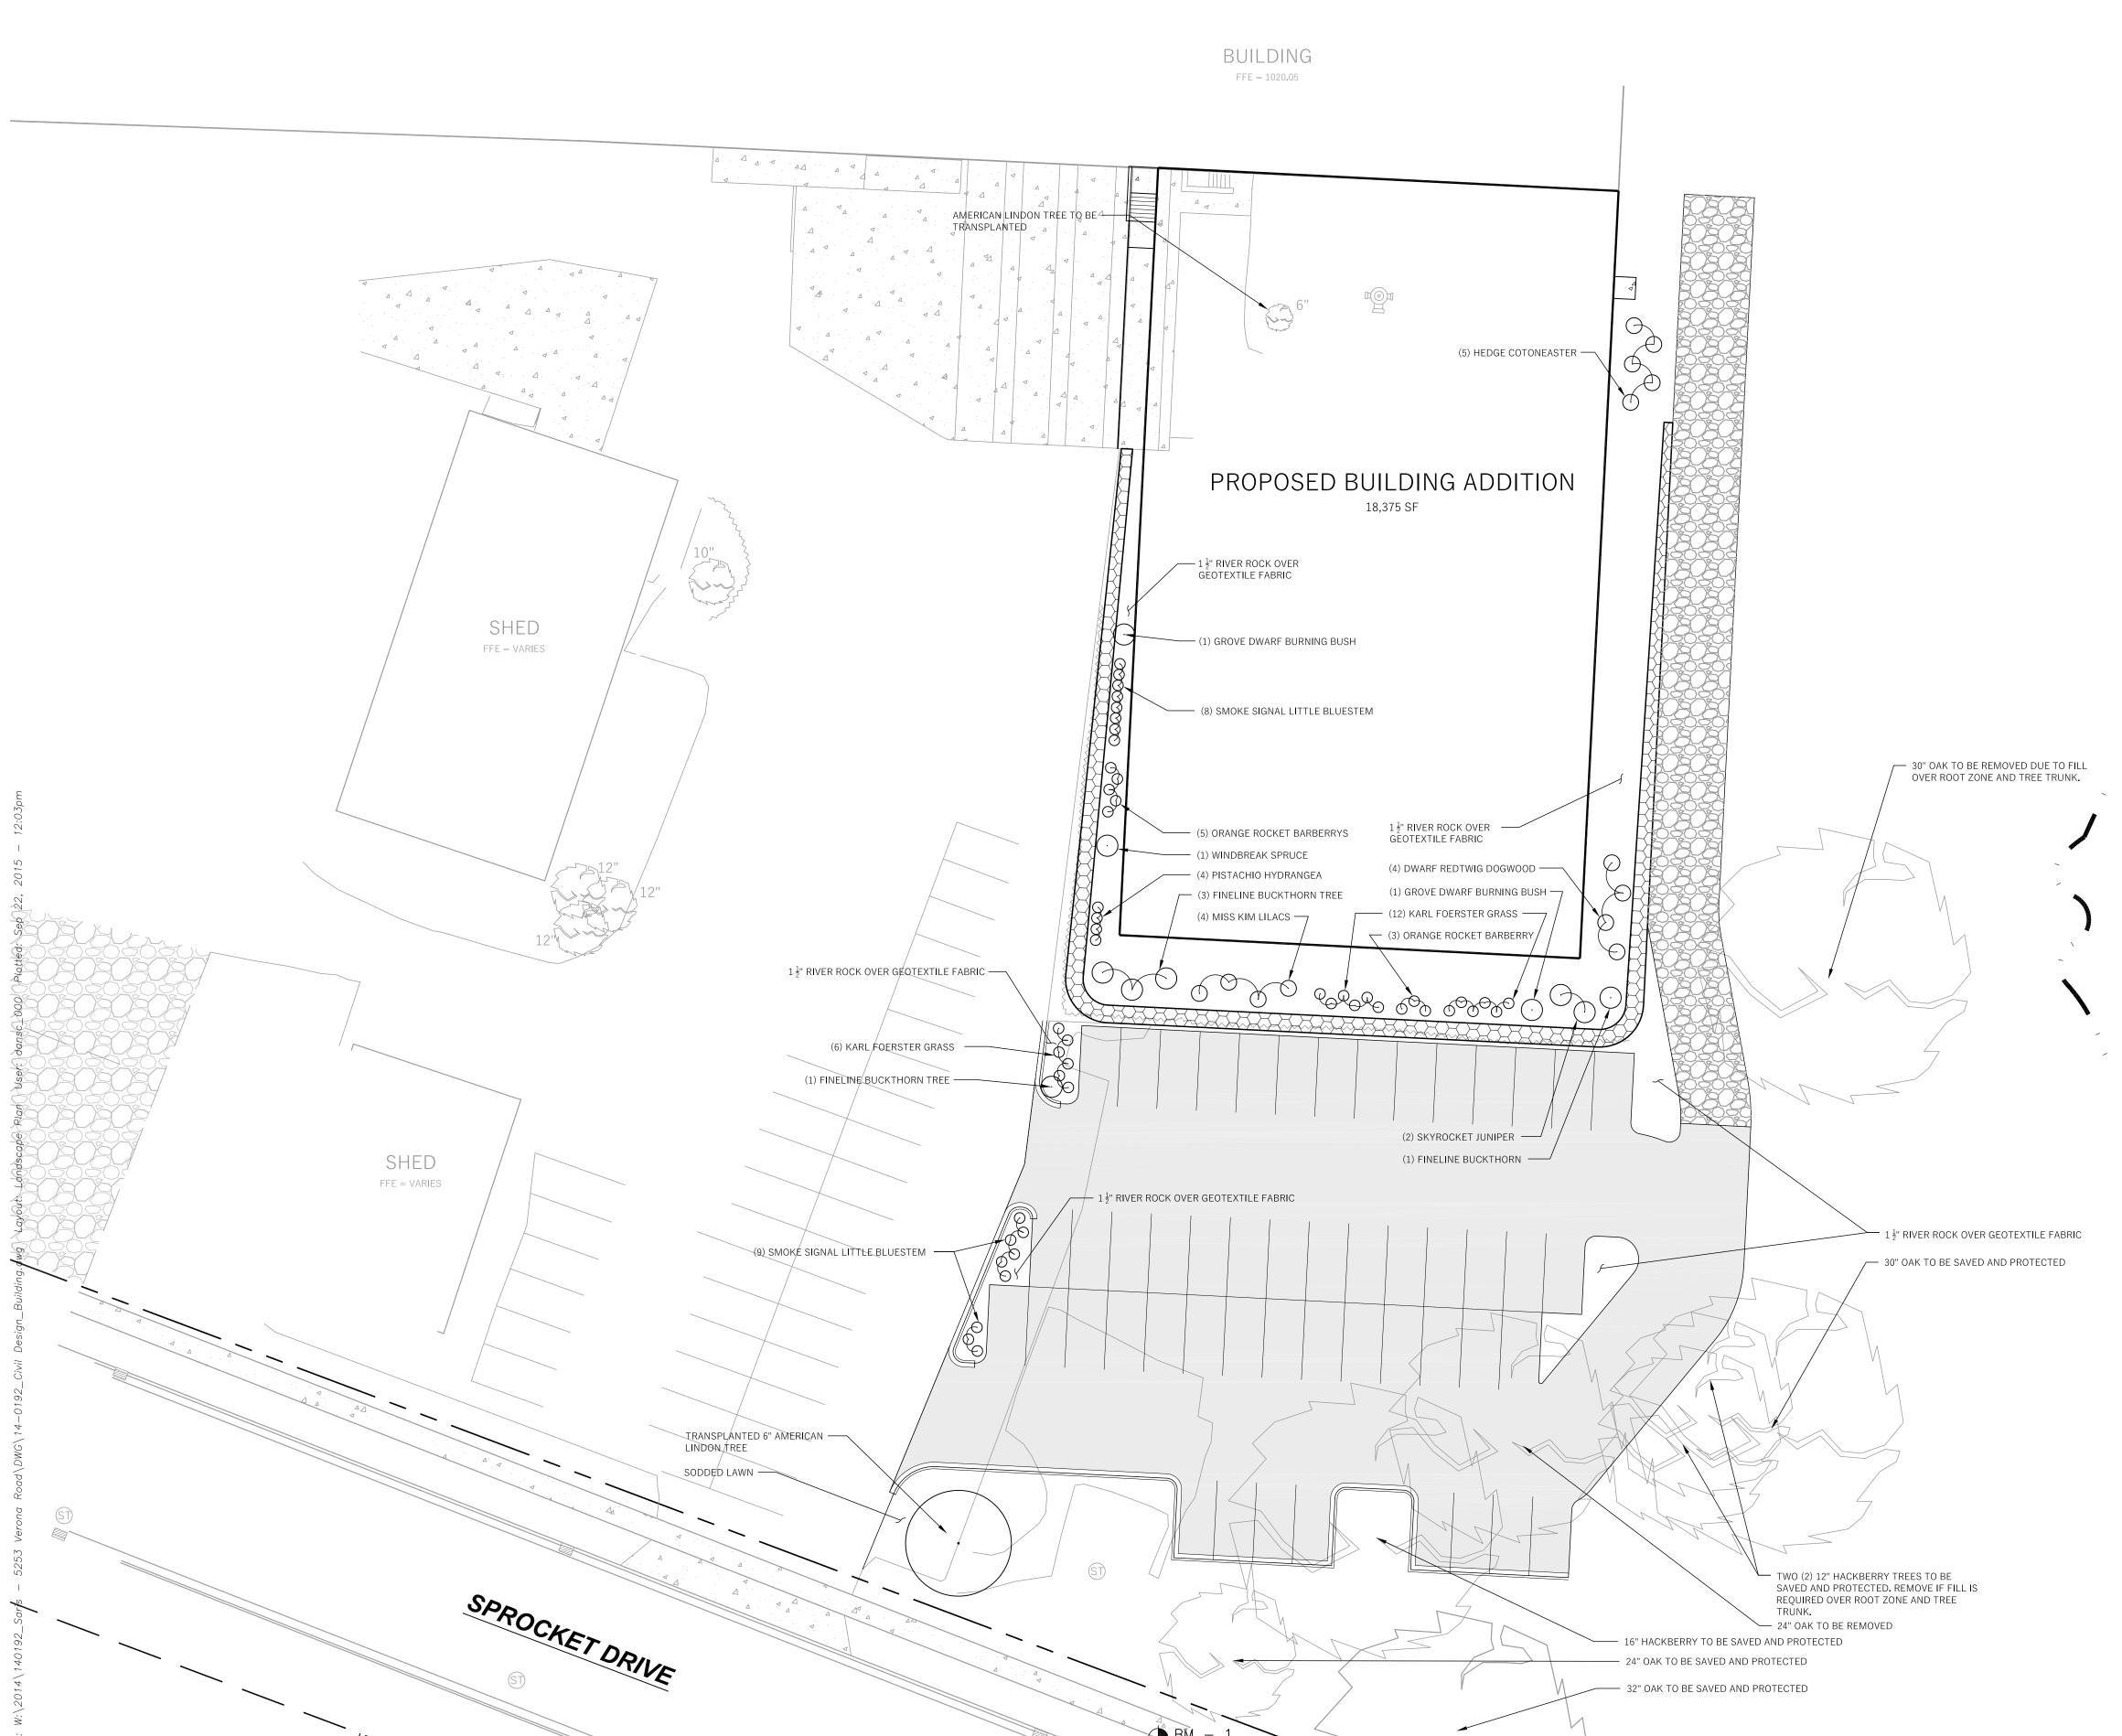




Revisions: Date: Description:

> 5' 10' 20' 14-0192

SCHEMATIC 9/18/2015




### **LEGEND (PROPOSED)**

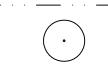PROPOSED PROPERTY BOUNDARY ---- · --- EASEMENT BUILDING FOOTPRINT ====== 18" CURB AND GUTTER 4 CONCRETE PAVEMENT GRAVEL PAVEMENT



---- TOP OF KETTLE LIMITS (AT OVERFLOW ELEVATION)

PROPOSED PLANTING



### **GENERAL NOTES**

- 1. UNDERLYING SITE CONTOURS AND INFORMATION BASED ON TOPOGRAPHIC & UTILITY DATA AS PROVIDED TO WYSER ENGINEERING, INFORMATION AVAILIBLE ON THE DANE COUNTY GIS SYSTEM (DCIMAP), AND FIELD WORK PERFORMED BY WYSER ENGIENERING ON SEPTEMBER 15, 2015. WYSER ENGINEERING SHALL NOT BE HELD RESPONSIBLE FOR ANY ERRORS OR OMISSIONS THAT MAY ARISE AS A RESULT OF ERRONEOUS OR INCOMPLETE INFORMATION PROVIDED BY OTHERS. CONTRACTOR TO CONFIRM ALL ELEVATIONS, GENERAL DRAINAGE AND EARTHWORK REQUIREMENTS PRIOR TO CONSTRUCTION.
- 2. THE BENCHMARK LOCATIONS ARE SHOWN FOR REFERENCE ONLY ON THIS PLAN. THE BENCHMARKS SHALL BE VALIDATED BY LICENSED LAND SURVEYOR PRIOR TO CONSTRUCTION. CONTRACTOR ASSUMES RISK ASSOCIATED WITH BENCHMARK ELEVATIONS UNTIL CONFIRMED.
- 3. CONTRACTOR TO OBTAIN APPROPRIATE PERMITS FOR STREET OPENINGS & TO WORK WITHIN THE CITY'S LAND IF
- 4. WYSER ENGINEERING SHALL BE HELD HARMLESS AND DOES NOT WARRANT ANY DEVIATIONS BY THE OWNER OR CONTRACTOR FROM THE APPROVED CONSTRUCTION PLANS THAT MAY RESULT IN DISCIPLINARY ACTIONS BY REGULATORY AGENCIES.
- 5. IF ANY ERRORS, DISCREPANCIES, OR OMISSIONS WITHIN THE PLAN BECOME APPARENT, IT SHALL BE BROUGHT TO THE ATTENTION OF THE ENGINEER PRIOR TO CONSTRUCTION SO THAT CLARIFICATION OR REDESIGN MAY OCCUR.
- 6. ALL MUNICIPAL UTILITY CONNECTIONS, WORK IN ROW, PUBLIC OUTLOTS AND PUBLIC EASEMENTS SHALL BE IN ACCORDANCE WITH CITY OF FITCHBURG STANDARD SPECIFICATIONS.

### LANDSCAPE NOTES

- 1. GENERAL: LOCATE ALL UTILITIES PRIOR TO CONSTRUCTION. THE CONTRACTOR IS RESPONSIBLE FOR REPAIRING ANY DAMAGE DONE TO UTILITIES. CONTRACTOR MUST CALL 1-800-382-5544 FOR UTILITY LOCATIONS AT LEAST THREE DAYS PRIOR TO DIGGING. HAND DIG AND INSTALL ALL PLANTS THAT ARE NEAR EXISTING UTILITIES. PROTECT PREVIOUSLY INSTALLED WORK OF OTHER TRADES. CONTRACTOR IS RESPONSIBLE FOR STAKING THE PLANT MATERIALS FOR REVIEW BY OWNER PRIOR TO DIGGING AND PLACEMENT. THE LANDSCAPE CONTRACTOR SHALL COORDINATE ALL FINE GRADING AND RESTORATION WITH THE GRADING CONTRACTOR.
- 2. DELIVERY AND HANDLING: DO NOT DELIVER MORE PLANT MATERIALS THAN CAN BE PLANTED IN ONE DAY. DELIVER PLANTS WITH LEGIBLE IDENTIFICATION LABELS. PROTECT PLANTS DURING DELIVERY AND DO NOT PRUNE PRIOR TO DELIVERY. ALL TREES AND SHRUBS SHALL BE PLANTED ON THE DAY OF DELIVERY; IF THIS IS NOT POSSIBLE, PROTECT THAT STOCK NOT PLANTED BY STORING STOCK IN A SHADED AREA PROTECTING THE ROOT MASS WITH WET SOIL, MOSS OR OTHER SUITABLE MEDIA AND KEEPING WELL WATERED. DO NOT REMOVE CONTAINER GROWN STOCK FROM CONTAINERS BEFORE TIME OF PLANTING. DO NOT PICK UP CONTAINER OR BALLED PLANTS BY STEM OR ROOTS. ALL PLANTS SHALL BE LIFTED AND HANDLED FROM THE BOTTOM OF THE BALL. PERFORM ACTUAL PLANTING ONLY WHEN WEATHER AND SOIL CONDITIONS ARE SUITABLE IN ACCORDANCE WITH LOCALLY ACCEPTED PRACTICES.
- 3. GUARANTEE: THE CONTRACTOR SHALL GUARANTEE ALL PLANTS THROUGH ONE (1) YEAR AFTER ACCEPTANCE BY OWNER. PLANTS SHALL BE ALIVE AND IN GOOD HEALTHY AND FLOURISHING CONDITION AT THE END OF THE GUARANTEE PERIOD. THE CONTRACTOR SHALL REPLACE WITHOUT COST TO THE OWNER ANY PLANTS THAT ARE DEAD OR NOT IN A VIGOROUS THRIVING CONDITION. REPLACEMENT PLANTS SHALL BE OF THE SAME KIND AND SIZE AS ORIGINALLY SPECIFIED UNLESS OTHERWISE DIRECTED BY OWNER. RESTORE BEDS AS NECESSARY FOLLOWING PLANT REPLACEMENT, INCLUDING BUT NOT LIMITED TO BEDDING, EDGING, MULCH, GRASS, ETC. REPAIR DAMAGE TO OTHER PLANTS OR LAWNS DURING PLANT REPLACEMENT AT NO COST TO OWNER. CONTRACTOR SHALL PROVIDE A TWO (2)-YEAR STRAIGHTENING GUARANTEE FOR ALL TREES.
- MATERIALS PLANTS: ALL PLANTS SHALL CONFORM TO THE AMERICAN STANDARD FOR NURSERY STOCK ANSI Z60.1-2004. PLANTS SHALL BE TRUE TO SPECIES AND VARIETY SPECIFIED AND NURSERY GROWN IN ACCORDANCE WITH GOOD HORTICULTURAL PRACTICES UNDER CLIMATIC CONDITIONS SIMILAR TO THOSE IN THE LOCALITY OF THE PROJECT FOR AT LEAST 2 YEARS. PLANTS SHALL BE FRESHLY DUG (DURING THE MOST RECENT FAVORABLE HARVEST SEASON). PLANTS SHALL BE SO TRAINED IN DEVELOPMENT AND APPEARANCE AS TO BE UNQUESTIONABLY SUPERIOR IN FORM, COMPACTNESS, AND SYMMETRY. PLANTS SHALL BE SOUND, HEALTHY, VIGOROUS, WELL BRANCHED AND DENSELY FOLIATED WHEN IN LEAF, AND FREE OF DISEASE AND INSECTS (ADULT EGGS, PUPAE OR LARVAE). THEY SHALL HAVE HEALTHY, WELL-DEVELOPED ROOT SYSTEMS AND SHALL BE FREE FROM PHYSICAL DAMAGE OR OTHER CONDITIONS THAT WOULD PREVENT THRIVING GROWTH, PLANTS SHALL BE OF THE HIGHEST QUALITY, HAVE TYPICAL GROWTH HABITS FOR THEIR SPECIES, BE SOUND, HEALTHY, VIGOROUS AND FREE OF INJURY. PARKWAY TREES AND PARKING LOT TREES SHALL HAVE A MINIMUM BRANCHING HEIGHT OF SIX (6) FEET ABOVE THE GROUND TO ALLOW ADEQUATE VISUAL AND PHYSICAL CLEARANCE.
  - MATERIALS SOIL PLANTING SOIL /COMPACTED TOPSOIL SHALL MEET THESE REQUIREMENTS PLANTING SOIL TO BE A MINIMUM 6" DEPTH, UNLESS OTHERWISE SPECIFIED AS ABOVE OR ON DETAILS. TOPSOIL TO BE CLEAN, FRIABLE LOAM FROM LOCAL SOURCE, FREE FROM STONES OR DEBRIS OVER 3/4" IN DIAMETER, AND FREE FROM TOXINS. TOPSOIL SHALL HAVE A pH BETWEEN 6 AND 7. TOPSOIL AND PLANTING SOIL SHALL BE TESTED TO CONFORM TO THESE SPECIFICATIONS AND SHALL BE AMENDED TO MEET THESE SPECIFICATIONS. DO NOT PLACE FROZEN OR MUDDY TOPSOIL. APPLY SOIL AMENDMENTS TO ALL LANDSCAPE BEDS PER SOIL TEST.
- 6. SEEDING: ALL DISTURBED AREAS SHALL BE SEEDED AS SPECIFIED IN THESE NOTES.
- 7. MATERIALS SEED: ALL LAWN SEED SHALL BE EARTH CARPET'S 'BOULEVARD' OR EQUIVALENT AS APPROVED BY THE OWNER'S REPRESENTATIVE, INSTALLED PER MANUFACTURER'S RECOMMENDATIONS. IN ADDITION TO LAWN SEED. ANNUAL RYE SHALL BE APPLIED TO ALL DISTURBED AREAS AT A RATE OF 1 1/2 LBS PER 1000 SQUARE FEET. FERTILIZE AND MULCH PER MANUFACTURER'S RECOMMENDATIONS.
- 8. MATERIALS FERTILIZER AND MULCH: TREES PLANTED IN SEEDED LAWN AREAS SHALL RECEIVE 3" DEPTH, FINELY SHREDDED, WEED FREE, HARDWOOD BARK MULCH (DYE-FREE) OVER ENTIRE BED, UNLESS OTHERWISE SPECIFIED ON PLANS. FERTILIZER SHALL BE IN ACCORDANCE WITH APPLICABLE LOCAL, COUNTY AND STATE OF WISCONSIN
- 9. PRUNING: THE CONTRACTOR SHALL PRUNE ALL TREES AND REPAIR ANY INJURIES THAT OCCURRED DURING THE PLANTING PROCESS. DOUBLE LEADERS, DEAD BRANCHES, AND LIMBS DAMAGED OR BROKEN DURING THE PLANTING PROCESS SHALL BE PRUNED. THIS SHALL BE THE ONLY PRUNING ALLOWED AT PLANTING. PRUNING SHALL CONFORM TO AMERICAN STANDARD FOR TREE CARE OPERATIONS, ANSI A300. PRUNE TREES IN ACCORDANCE WITH NAA GUIDELINES. DO NOT TOP TREES. PRUNE SHRUBS ACCORDING TO STANDARD HORTICULTURAL PRACTICES. ON CUTS OVER 3/4" IN DIAMETER AND BRUISES OR SCARS ON BARK, TRACE THE INJURED CAMBIUM LAYER BACK TO LIVING TISSUE AND REMOVE. SMOOTH AND SHAPE WOUNDS SO AS NOT TO RETAIN WATER AND COAT THE TREATED AREA WITH AN APPROVED ANTISEPTIC TREE PAINT.
- 10. CLEANUP: DISPOSED OF EXCESS SOIL. REMOVE ALL CUTTINGS AND WASTE MATERIALS. SOIL, BRANCHES, BINDING AND WRAPPING MATERIALS, REJECTED PLANTS, OR OTHER DEBRIS RESULTING FROM ANY PLANTING SHALL BE PROMPTLY CLEANED UP AND REMOVED. THE WORK AREA SHALL BE KEPT SAFE AND NEAT AT ALL TIMES UNTIL THE CLEANUP OPERATION IS COMPLETED. UNDER NO CONDITION SHALL THE ACCUMULATION OF SOIL, BRANCHES OR OTHER DEBRIS BE ALLOWED UPON A PUBLIC PROPERTY IN SUCH A MANNER AS TO RESULT IN A PUBLIC HAZARD. LIKEWISE, UNDER NO CIRCUMSTANCES SHALL ANY DEBRIS OR INCIDENTAL MATERIALS BE ALLOWED UPON ADJACENT PRIVATE PROPERTY.
- 11. MAINTENANCE: (CONTRACTOR) FOR ALL PLANTINGS, BUFFER AREAS AND SEEDED LAWN AREAS: THE CONTRACTOR SHALL MAINTAIN ALL PLANTINGS AND LAWN AREAS FOR AT LEAST A PERIOD OF 30 DAYS, OR UNTIL FINAL ACCEPTANCE FROM THE OWNER. THE CONTRACTOR IS RESPONSIBLE FOR ADEQUATELY WATERING PLANTS AND LAWN DURING THIS 30 DAY ESTABLISHMENT PERIOD. CONTRACTOR IS RESPONSIBLE FOR THE ESTABLISHMENT OF HEALTHY VIGOROUS PLANT MATERIALS AND LAWN/TURFGRASS GROWTH. CONTRACTOR IS ALSO RESPONSIBLE FOR ANY PRUNING OF PLANT MATERIALS, AND SHAPING AND/OR REPLACEMENT OF DEFICIENT BARK MULCH DURING THIS PERIOD. LONG TERM PLANT MATERIALS AND LAWN/TURFGRASS MAINTENANCE AND ANY PROGRAM FOR SUCH IS THE RESPONSIBILITY OF THE OWNER. ALL PLANTINGS AND LAWN/TURFGRASS AREAS SHALL BE MAINTAINED IN A MANICURED CONDITION.
- 12. MAINTENANCE: (OWNER) THE OWNER IS RESPONSIBLE FOR THE CONTINUED MAINTENANCE, REPAIR AND REPLACEMENT OF ALL LANDSCAPING MATERIALS AND BARRIERS AS NECESSARY (PER CITY ORDINANCES) FOLLOWING THE ONE (1) YEAR CONTRACTOR GUARANTEE PERIOD.



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Revisions: Date: Description:

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Number 14-0192 SCHEMATIC 09/18/2015

Sheet Number

foam in place - closed cel fireplace - gas fired fireplace - wood burning freezer - weight freezer - upright foot, or feet

galvanized grab bar general contracto ground fault interrupt glass fiber reinforced polymer gross square feet, or geotextile separation fabric

hardwood hardware hollow metal horizontal heat pump hanging rod and shelf heating ventilation and air conditioning incandescent include, or including insulation interior

hollow core

kilopounds per square inch

linear, or lineal, or linen closet liquid propane liquid propane gas regulato light weight

mechanical medium mechanical electrical plumbing

miscellaneous molding masonny opening mounted mounting metal

network interface device outside diameter owner furnished contractor installed owner furnished owner installed ordinary high water mark

oven - double ov-dbl-e oven - double - electric

panel board, or pull box panel board - structured wiring pounds per cubic foot plate, or property line plastic laminate plumbing pounds per lineal foot preliminary

parallel strand board pressure treated, or preservative treated, or pressure

radiant heater - hot water baseboard

refrigerator refrigerator with ice maker radiant heater - electric infra-red radiant heater - gas fired infra-red radiant heater - electric baseboard radiant heater - electric flat panel wall mount

rough opening right of way

sump pump and crock basin soil boring, or shower bas structured-composite cable shower door - glass hinge shower door - glass sliding square foot, or square fee shower head

solar panel - hot water solar panel - photovoltaic surge protection device stainless steel

to be determined telephone, or telecommunication toilet paper holder trash/recyclable- pullout drawer

television typical unexcavated urinal - floor mounted urinal - wall mounted

vinyl wall base

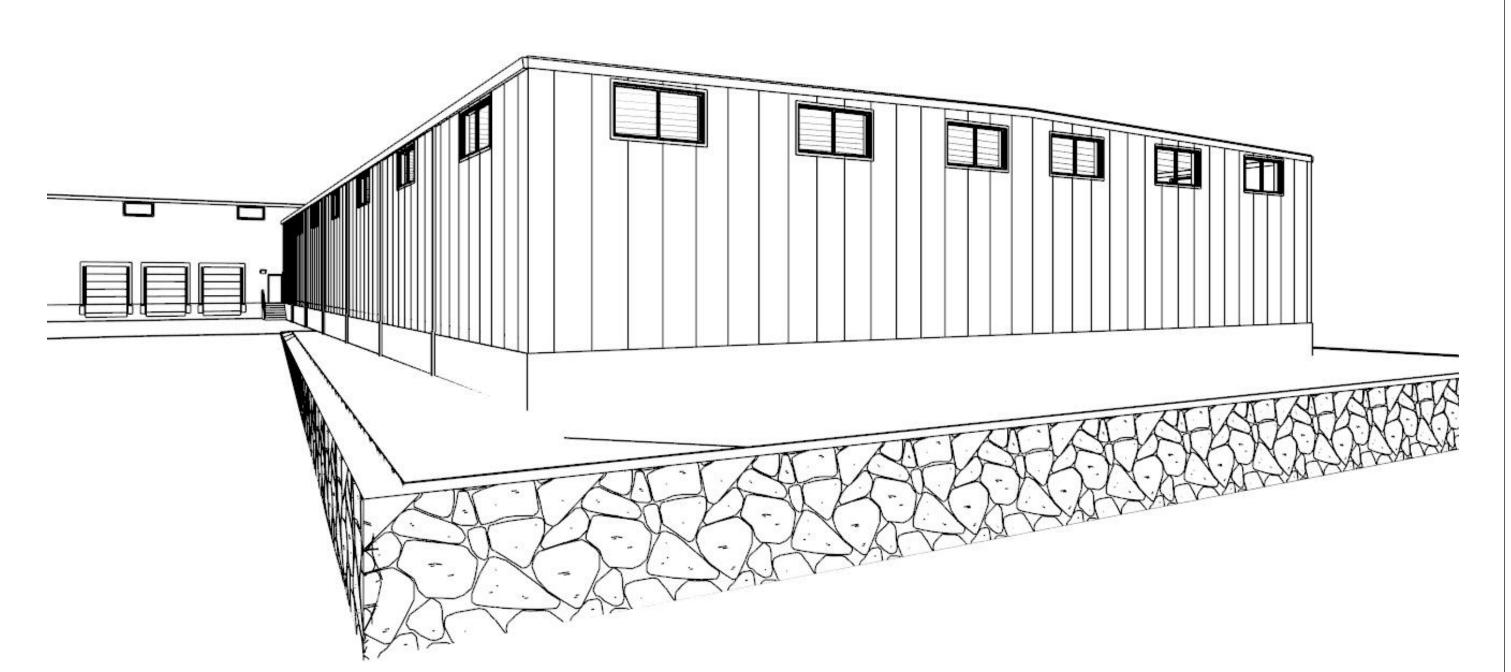
west, or wide, or width water closet wine cooler - under cabinet stacked washer and dryer combination - gas warming drawer

water filtration system water heater - electric water heater - gas water heater - tankless electric water heater - tankless gas water resistant, or weather resistan water softener set with internal brine tank welded wire reinforcemen

American Society of Civil Engineers International Building Code International Fuel Gas Code International Mechanical Cod International Plumbing Code National Design Specification

material keu

# Addition to Saris Cycling Group Lionshare Group, LLC



### <u>symbol key</u> These patterns may be used in plan or section to indicate material types. The same pattern may be used for different materials; these material identifications must be made within the context of the The following reference marks, symbols, and drafting conventions may be used throughout the document set. Special symbols not identified in this key will be identified on the drawing. drawing. If there is a discrepancy between a text description of a material and a pattern as described in Hidden Construction Line -Overhead Construction Line — — — — — — — plywood, OSB or other sheathing Right of May Center Line - ROW - ROW - ROW - ROW -Setback or Build-to Line Easement or other described boundary - - - - - - - -Electric, buried (OE overhead) — E — OE — OE Cable, buried (OC overhead) — C — OC — OC — OC – ele∨ation number interior elevation stone aggregate or granular fill structural grid line compacted or engineered fill sand or soil fines wood (finish trim, board, or molding) nominal lumber (board, stud, or timber) blocking (cut, planed or trimmed to a non-standard loose fill insulation — elevation elevation datum spray polyurethane foam insulation door identification fiberglass blanket insulation window identification wall identification

footing identification

### project notes

- 1. These notes describe typical project conditions and requirements; exceptions are
- 2. If a specification has been published with this project it will govern the project's material and performance requirements. Areas not covered by a specification will be governed by the standards and best practices of the construction trades, related industries, and professional societies. Details, notes, and instructions on the drawing set take precedence. All work will conform to the governing ordinances, codes, and regulations. If a discrepancy cannot be resolved, contact the architect for clarification.
- 3. The general contractor and subcontractors shall thoroughly familiarize themselves with the scope and nature of the new construction prior to the start of work.
- 4. The general contractor and subcontractors shall verify existing conditions prior to the start of work. Conditions which differ significantly from those anticipated as shown within these drawings shall be referred to the architect prior to the start of work.
- All work outside of the area of construction shall be protected from incidental damage. Any damage shall be repaired as new to the owner's satisfaction prior to the completion of construction.
- The general contractor shall plug and block penetrations through the exterior building envelope to prevent pest and nuisance animal infestation.

### project summary

Fitchburg, Dane County, WI

principal governing codes and ordinances Wisconsin Commercial Building Code, Chapters SPS 361-366 City of Fitchburg Chapter 22 Zoning Ordinance City of Fitchburg Chapter 25 Architectural and Design Review Ordinance

address: 5253 Verona Rd, Fitchburg, WI, 53511 zoning district: B-H Highway Business District parcel number: 225/0609-064-8201-2 description: Section 6 Township 6N Range 9E

### zoning restrictions

minimum lot area: 8,000 square feet minimum lot width: 60 feet minimum front setback: 25 feet minimum side setback: 10 feet side street setback: 20 feet rear setback: 20 feet maximum building height: three stories or 42 feet minimum open space: 15% minimum impervious surface ratio: 65%

### <u>building type and occupancy group</u>

F-1 moderate-hazard group Type IIB construction pre-engineered steel frame metal building slab on grade single story above grade plane protected with an NFPA 13 automatic sprinkler system no required fire separation from adjacent F-1 occupancy

the existing Group B area is separated from the Group F areas with a 2-hour fire wall the new and existing Group F areas are treated as a single building for area calculations tabulated area limitation = 15,500 square feet sprinkler area increase for a single-story above grade plane = 300% building perimeter with a frontage greater than 20 feet = 1,195 feet portion of the building perimeter with a frontage of 22 feet = 23% portion of the building perimeter with a frontage of 30 feet or greater = 77% weighted average of frontage = 28 feet frontage area increase = 61% calculated area limitation is 15,500 + 46,500 + 9,455 = 71,455 square feet actual area of new + existing building = 67,575 square feet

occupant load and egress requirments

exit access travel distance = 250 feet

primary function is industrial tabulated occupant allowance = 100sqft gross per occupant calculated occupant load for new area is 18,375 / 100 = 19 occupants number of required exits based on occupant load = 1 common path of egress travel = 100 feet

### architectural drawing sheet index

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A2	lot layout plan
A3	foundation plan
A4	slab plan
A5	foundation details
A6	foundation details
A7	floor plan
A8	roof plan
A9	egress plan
A10	exterior elevations

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Group

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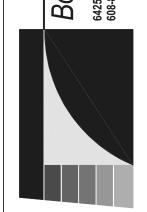
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project: 15058 date: 9/22/2015 drawn by: RLL

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Concept
Design
Not for Construction

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Addition to Saris Cycling Group I Lionshare Group, LLC 5253 Verona Rd, Fitchburg, WI, 53511

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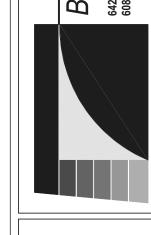
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Saris Cycling Group for hare Group, LLC

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# date | reference

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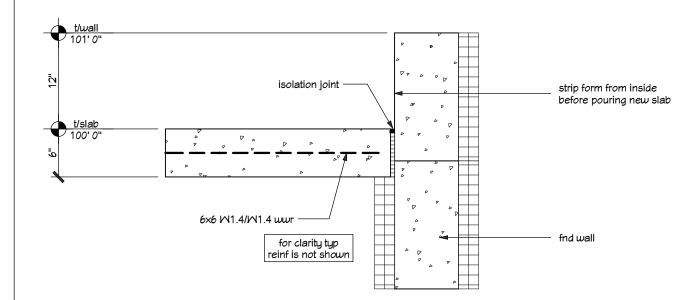
Addition to Saris Cycling Group for Lionshare Group, LLC 5253 Verona Rd, Fitchburg, WI, 53511

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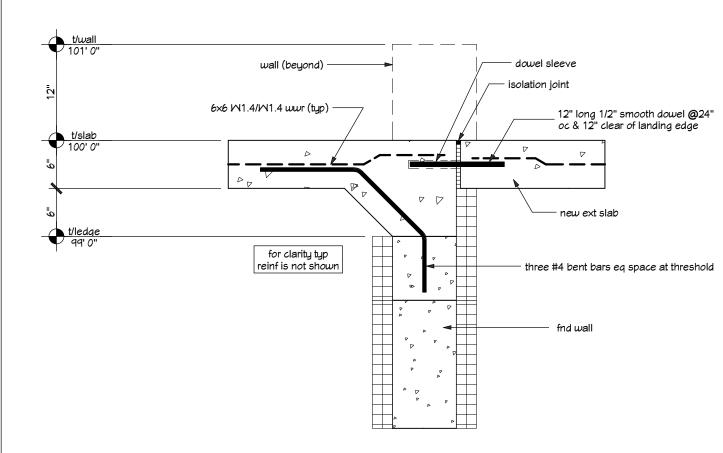
project: 15058 date: 9/22/2015 drawn by: RLL

1 wall section (typ)

scale: 1" = 1'0"



new slab at new wall (typ) scale: 1" = 1' 0"



new slab at door threshold

scale: 1" = 1' 0"

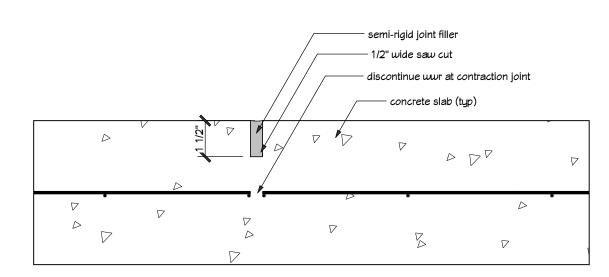
\_ 12" long 1/2" smooth dowel @24" oc & 12" clear of landing edge 6×6 M1.4/M1.4 wwr (typ) —— for clarity typ reinf is not shown

new slabs at door landing

- drill hole & epoxy adhesive \_ 12" long 1/2" smooth dowel @48" oc & 24" clear of slab edge existing slab ——— - 6×6 M1.4/M1.4 wwr strip existing icf form to below slab depth for clarity typ reinf is not shown — line of existing icf form – existing icf fnd core


new slab at existing wall

/ scale: 1" = 1' 0"




contraction joint (typ)

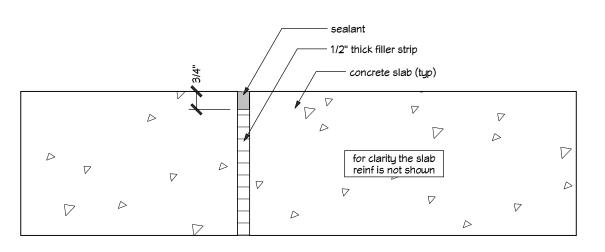
/ scale: 3" = 1' 0"



isolation joint (typ)

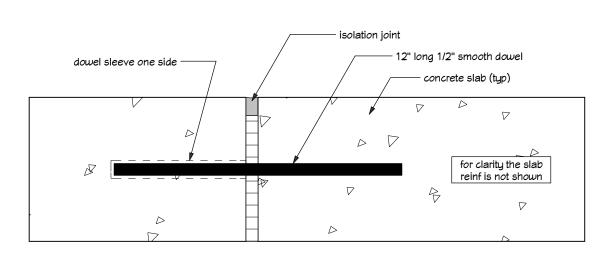


construction joint (typ)

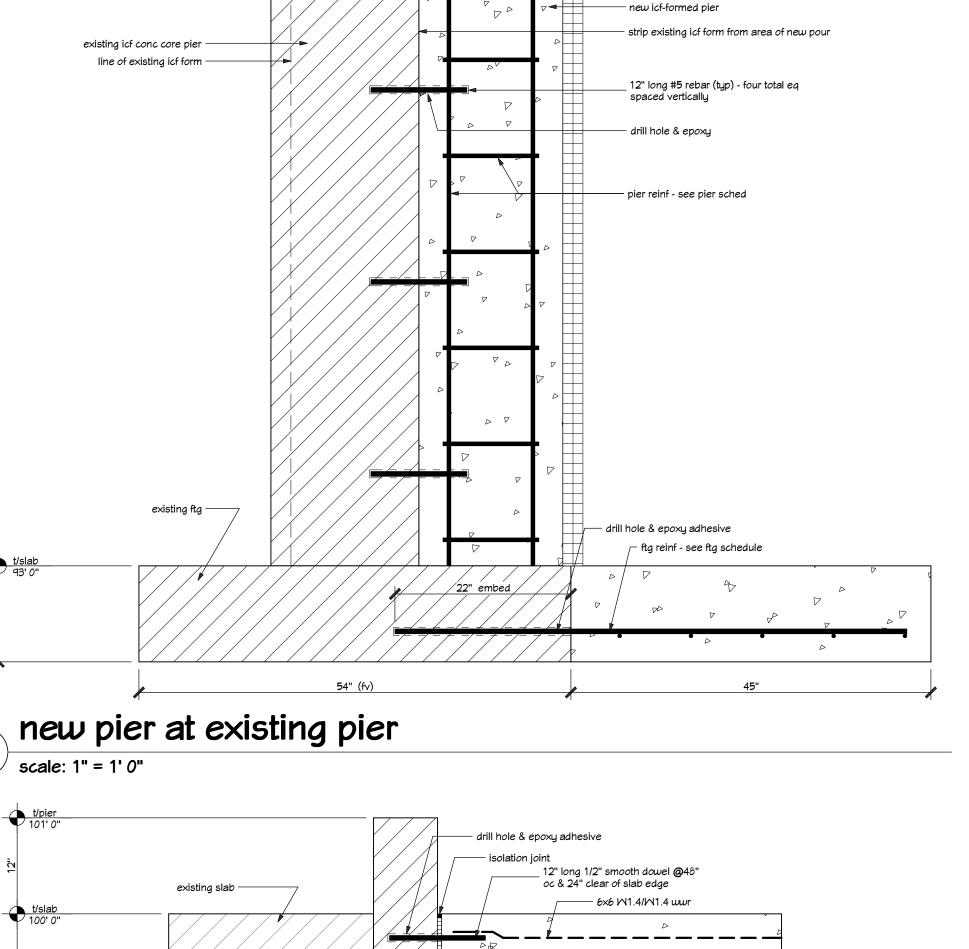

\_ 12" long 1/2" smooth dowel @48" oc & 24" clear of slab edge

- strip new icf form to below new slab

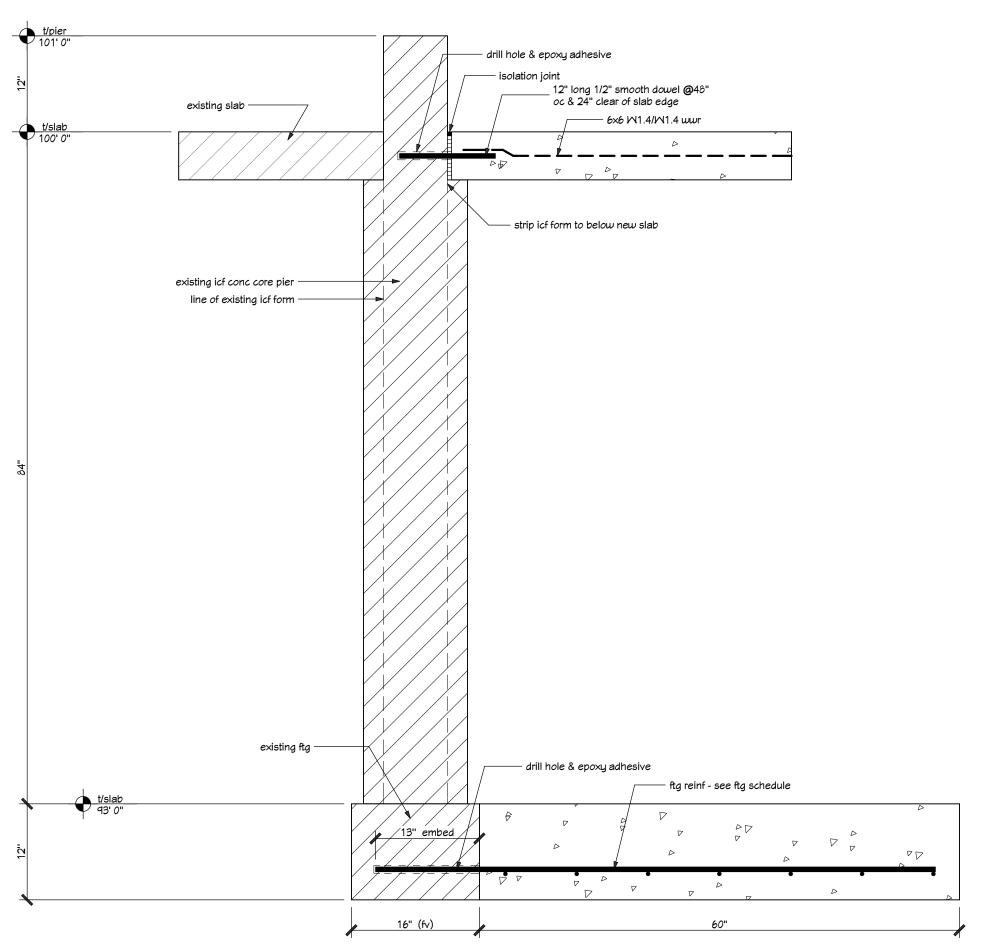— 6×6 M1.4/M1.4 wwr



new pier at existing wall

existing slab —

project: 15058 date: 9/22/2015

**Design** of for Construction

Bouril Design Studio, L 6425 Odana Rd Ste 2, Madison, WI 53719 608-833-3400 www.bourildesign.com

for

Saris


Addition to

s Cycling Group f e Group, LLC Fitchburg, WI, 53511

**A5** 

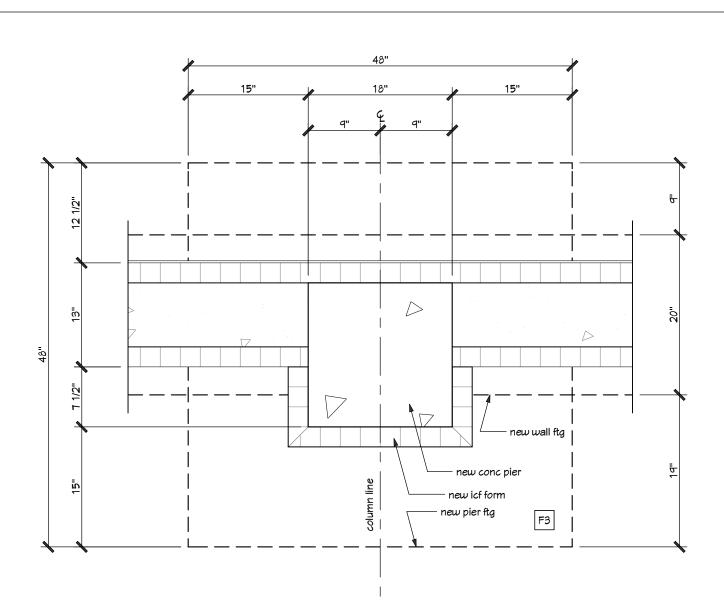
drawn by: RLL


A6




perimeter pier plan detail (typ)

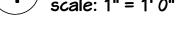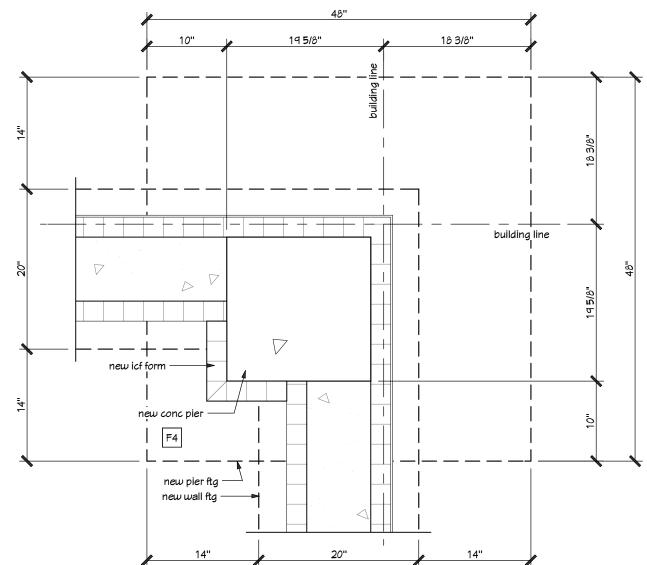scale: 1" = 1' 0"






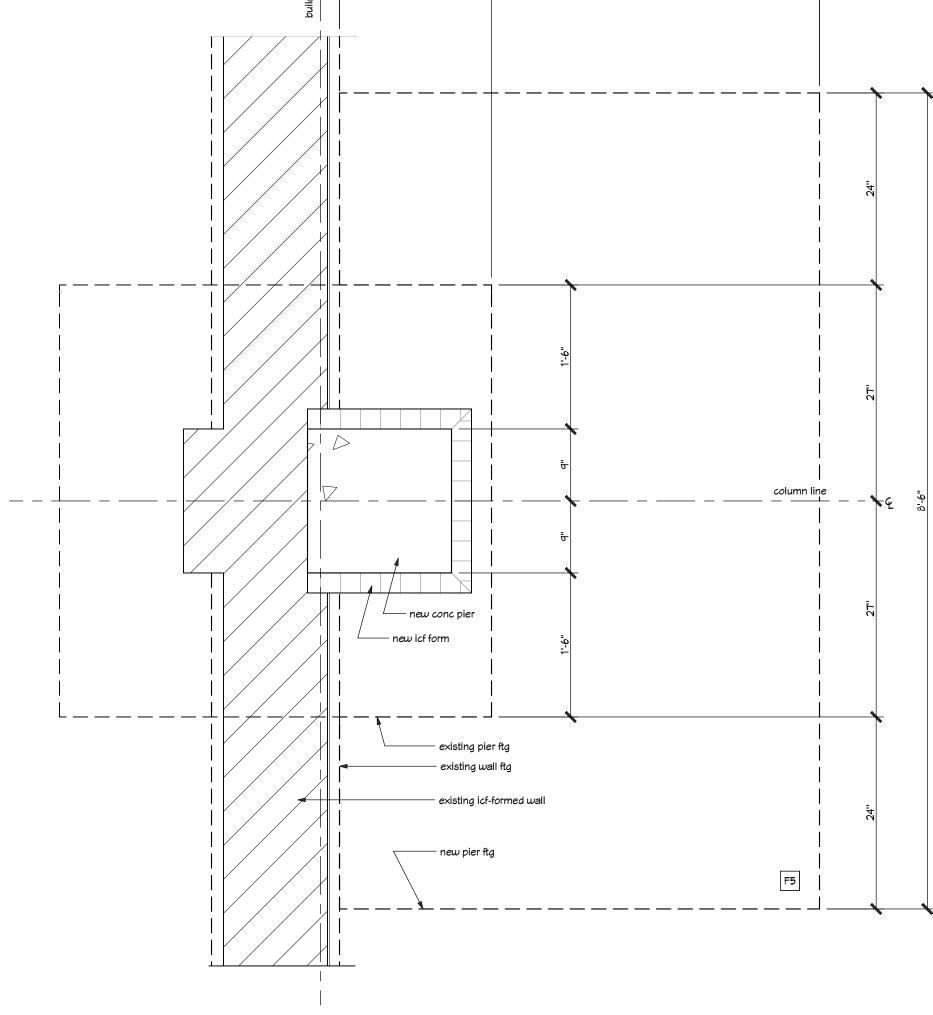corner pier plan detail (typ) 2 corner pi



perimeter pier plan detail (typ)

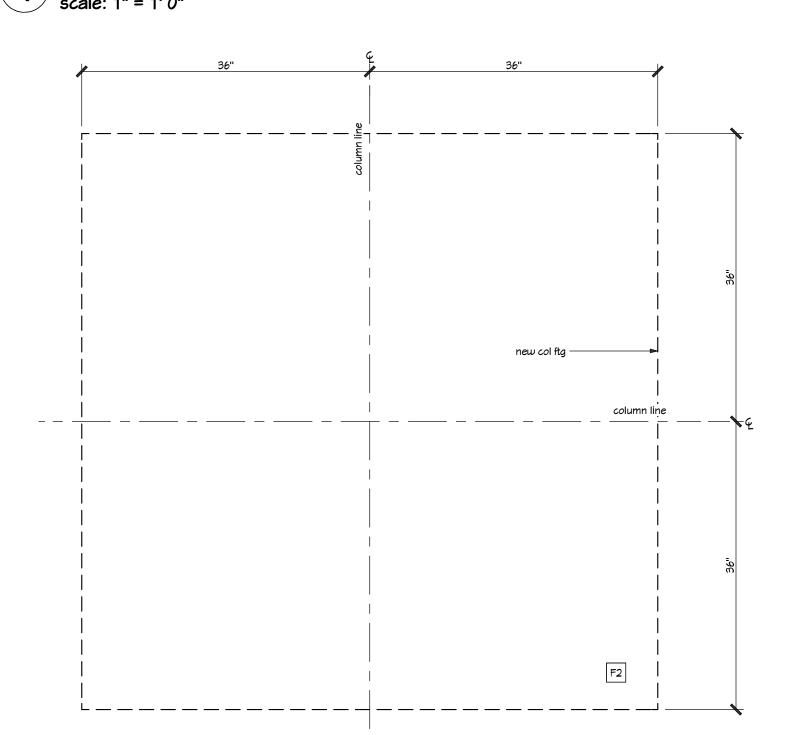
scale: 1" = 1' 0"



interior column footing plan detail (typ)

scale: 1" = 1'0"

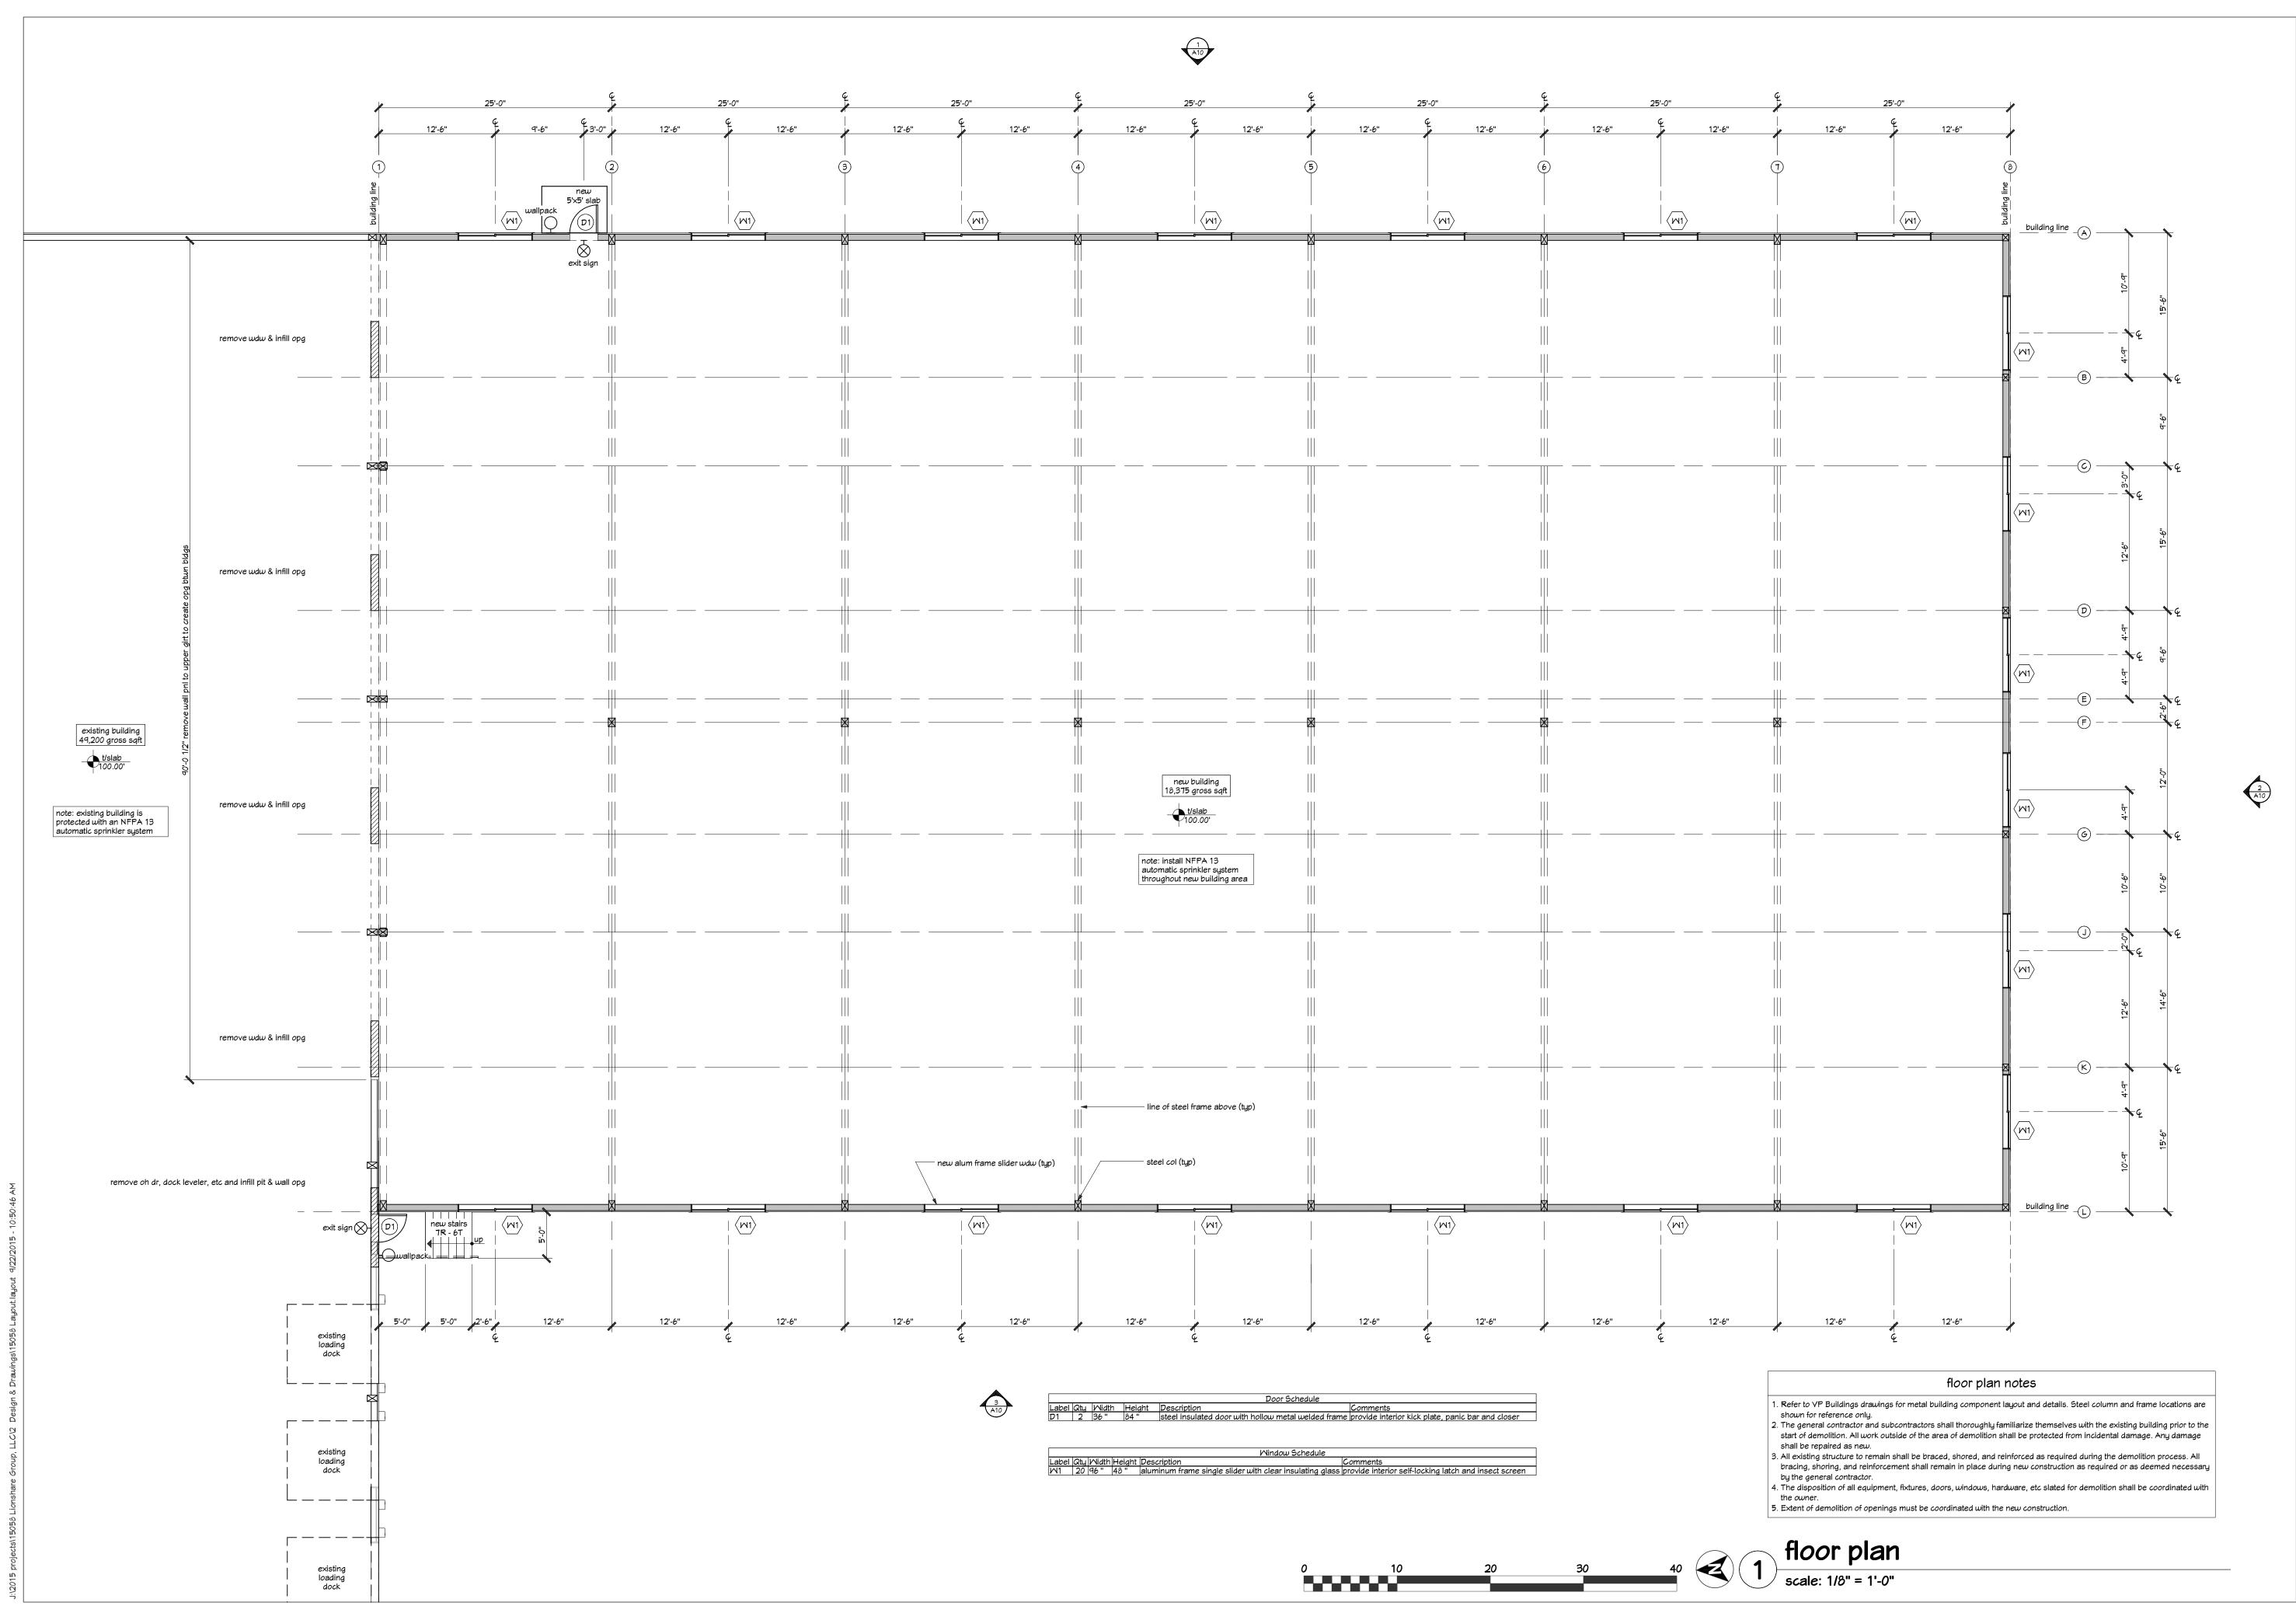3 not used scale: 1" = 1' 0"



Concept

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**Group** LLC 1, 53511

Cycling


Saris

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Group, LL Fitchburg, MI, 53

revision index
# date reference project: 15058 date: 9/22/2015

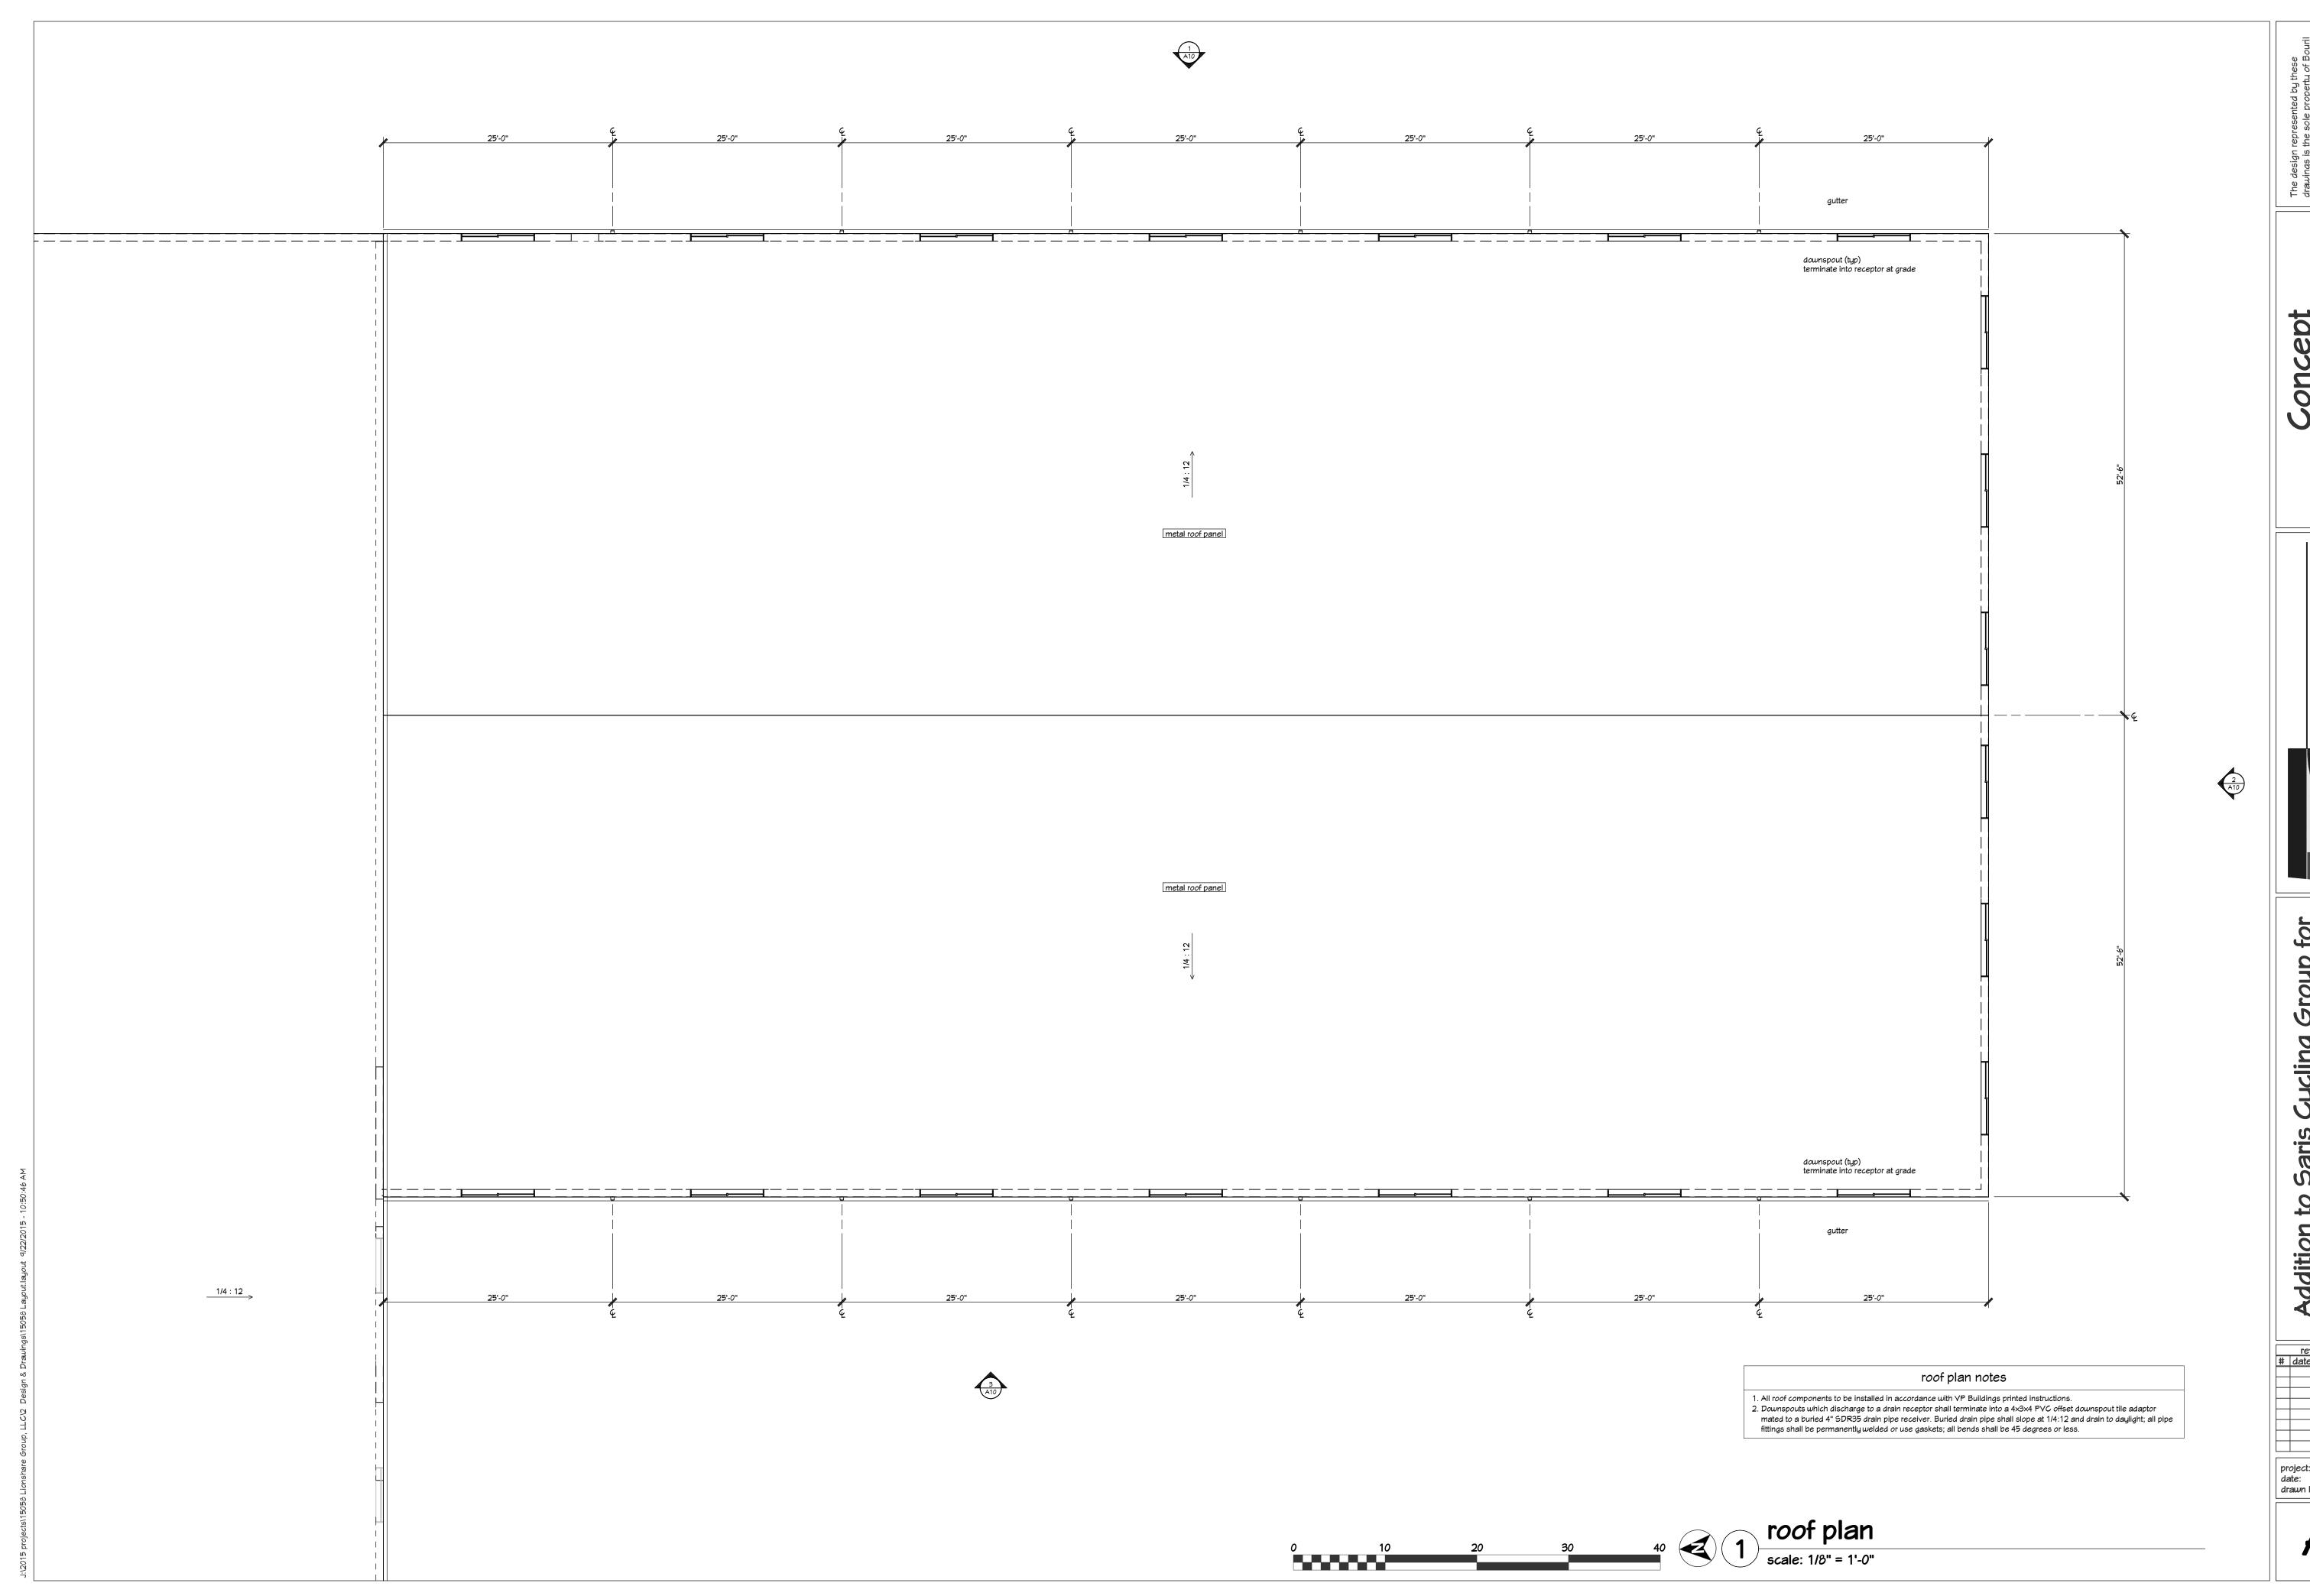drawn by: RLL



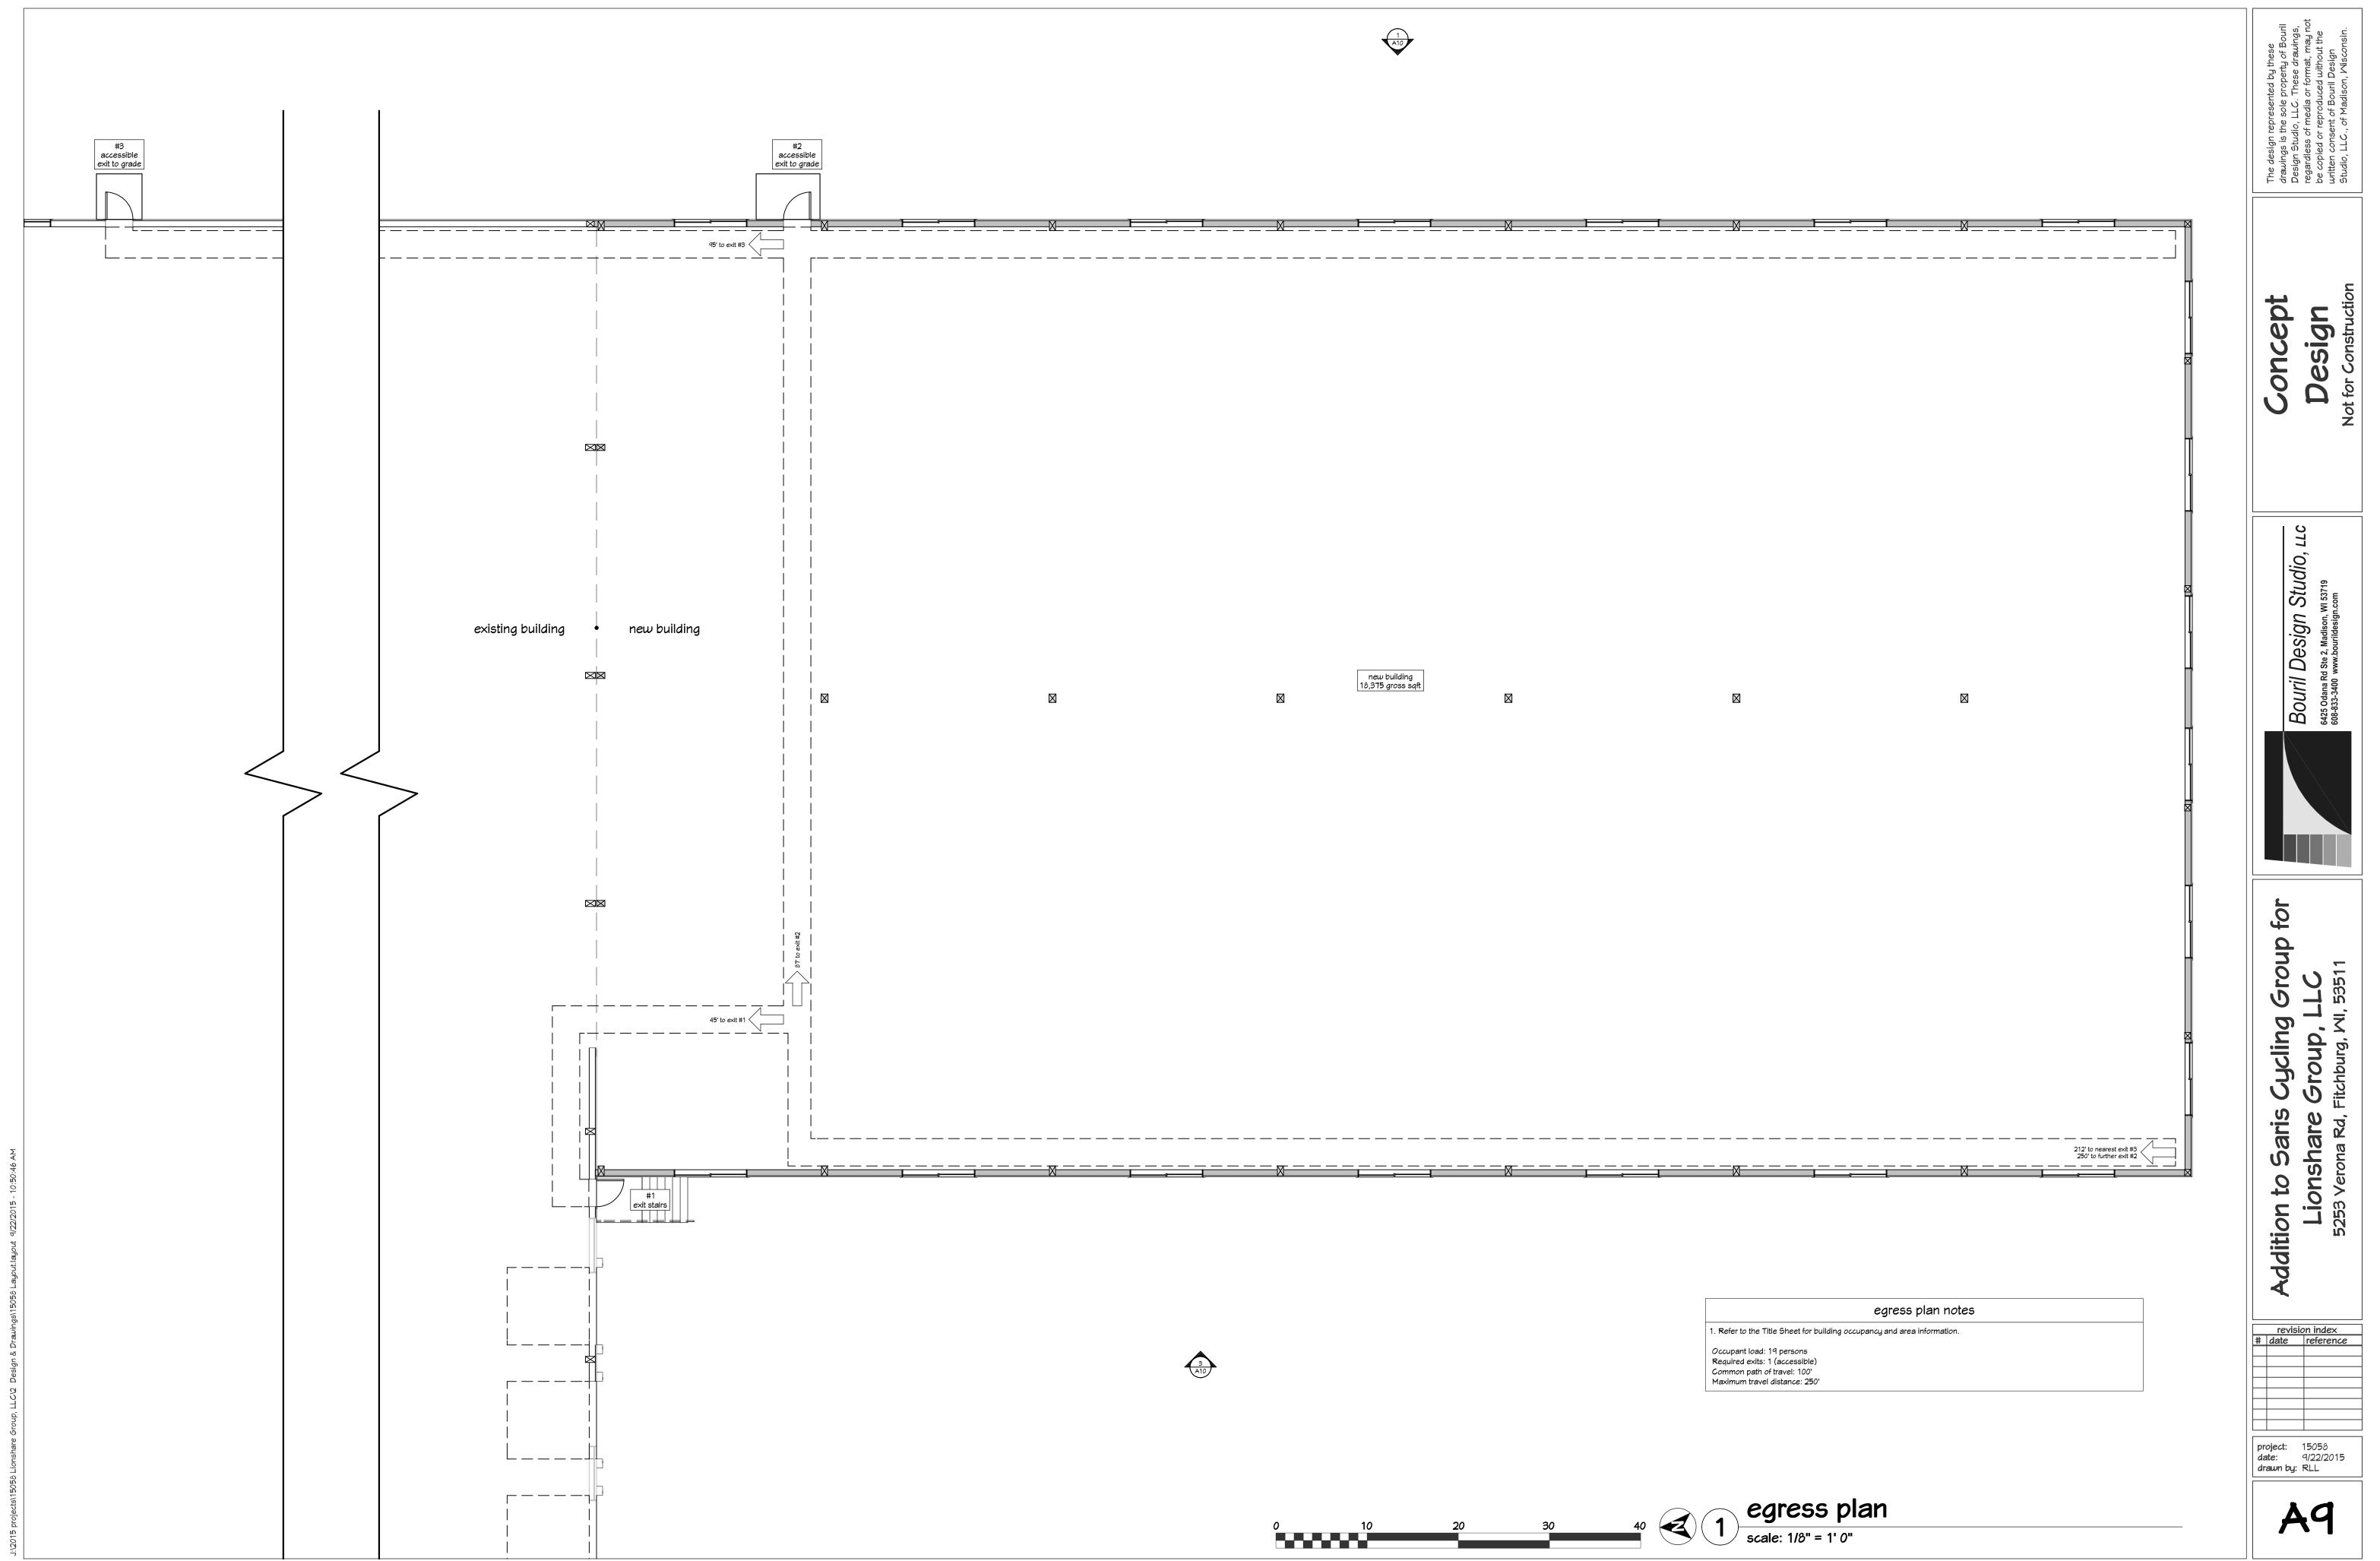
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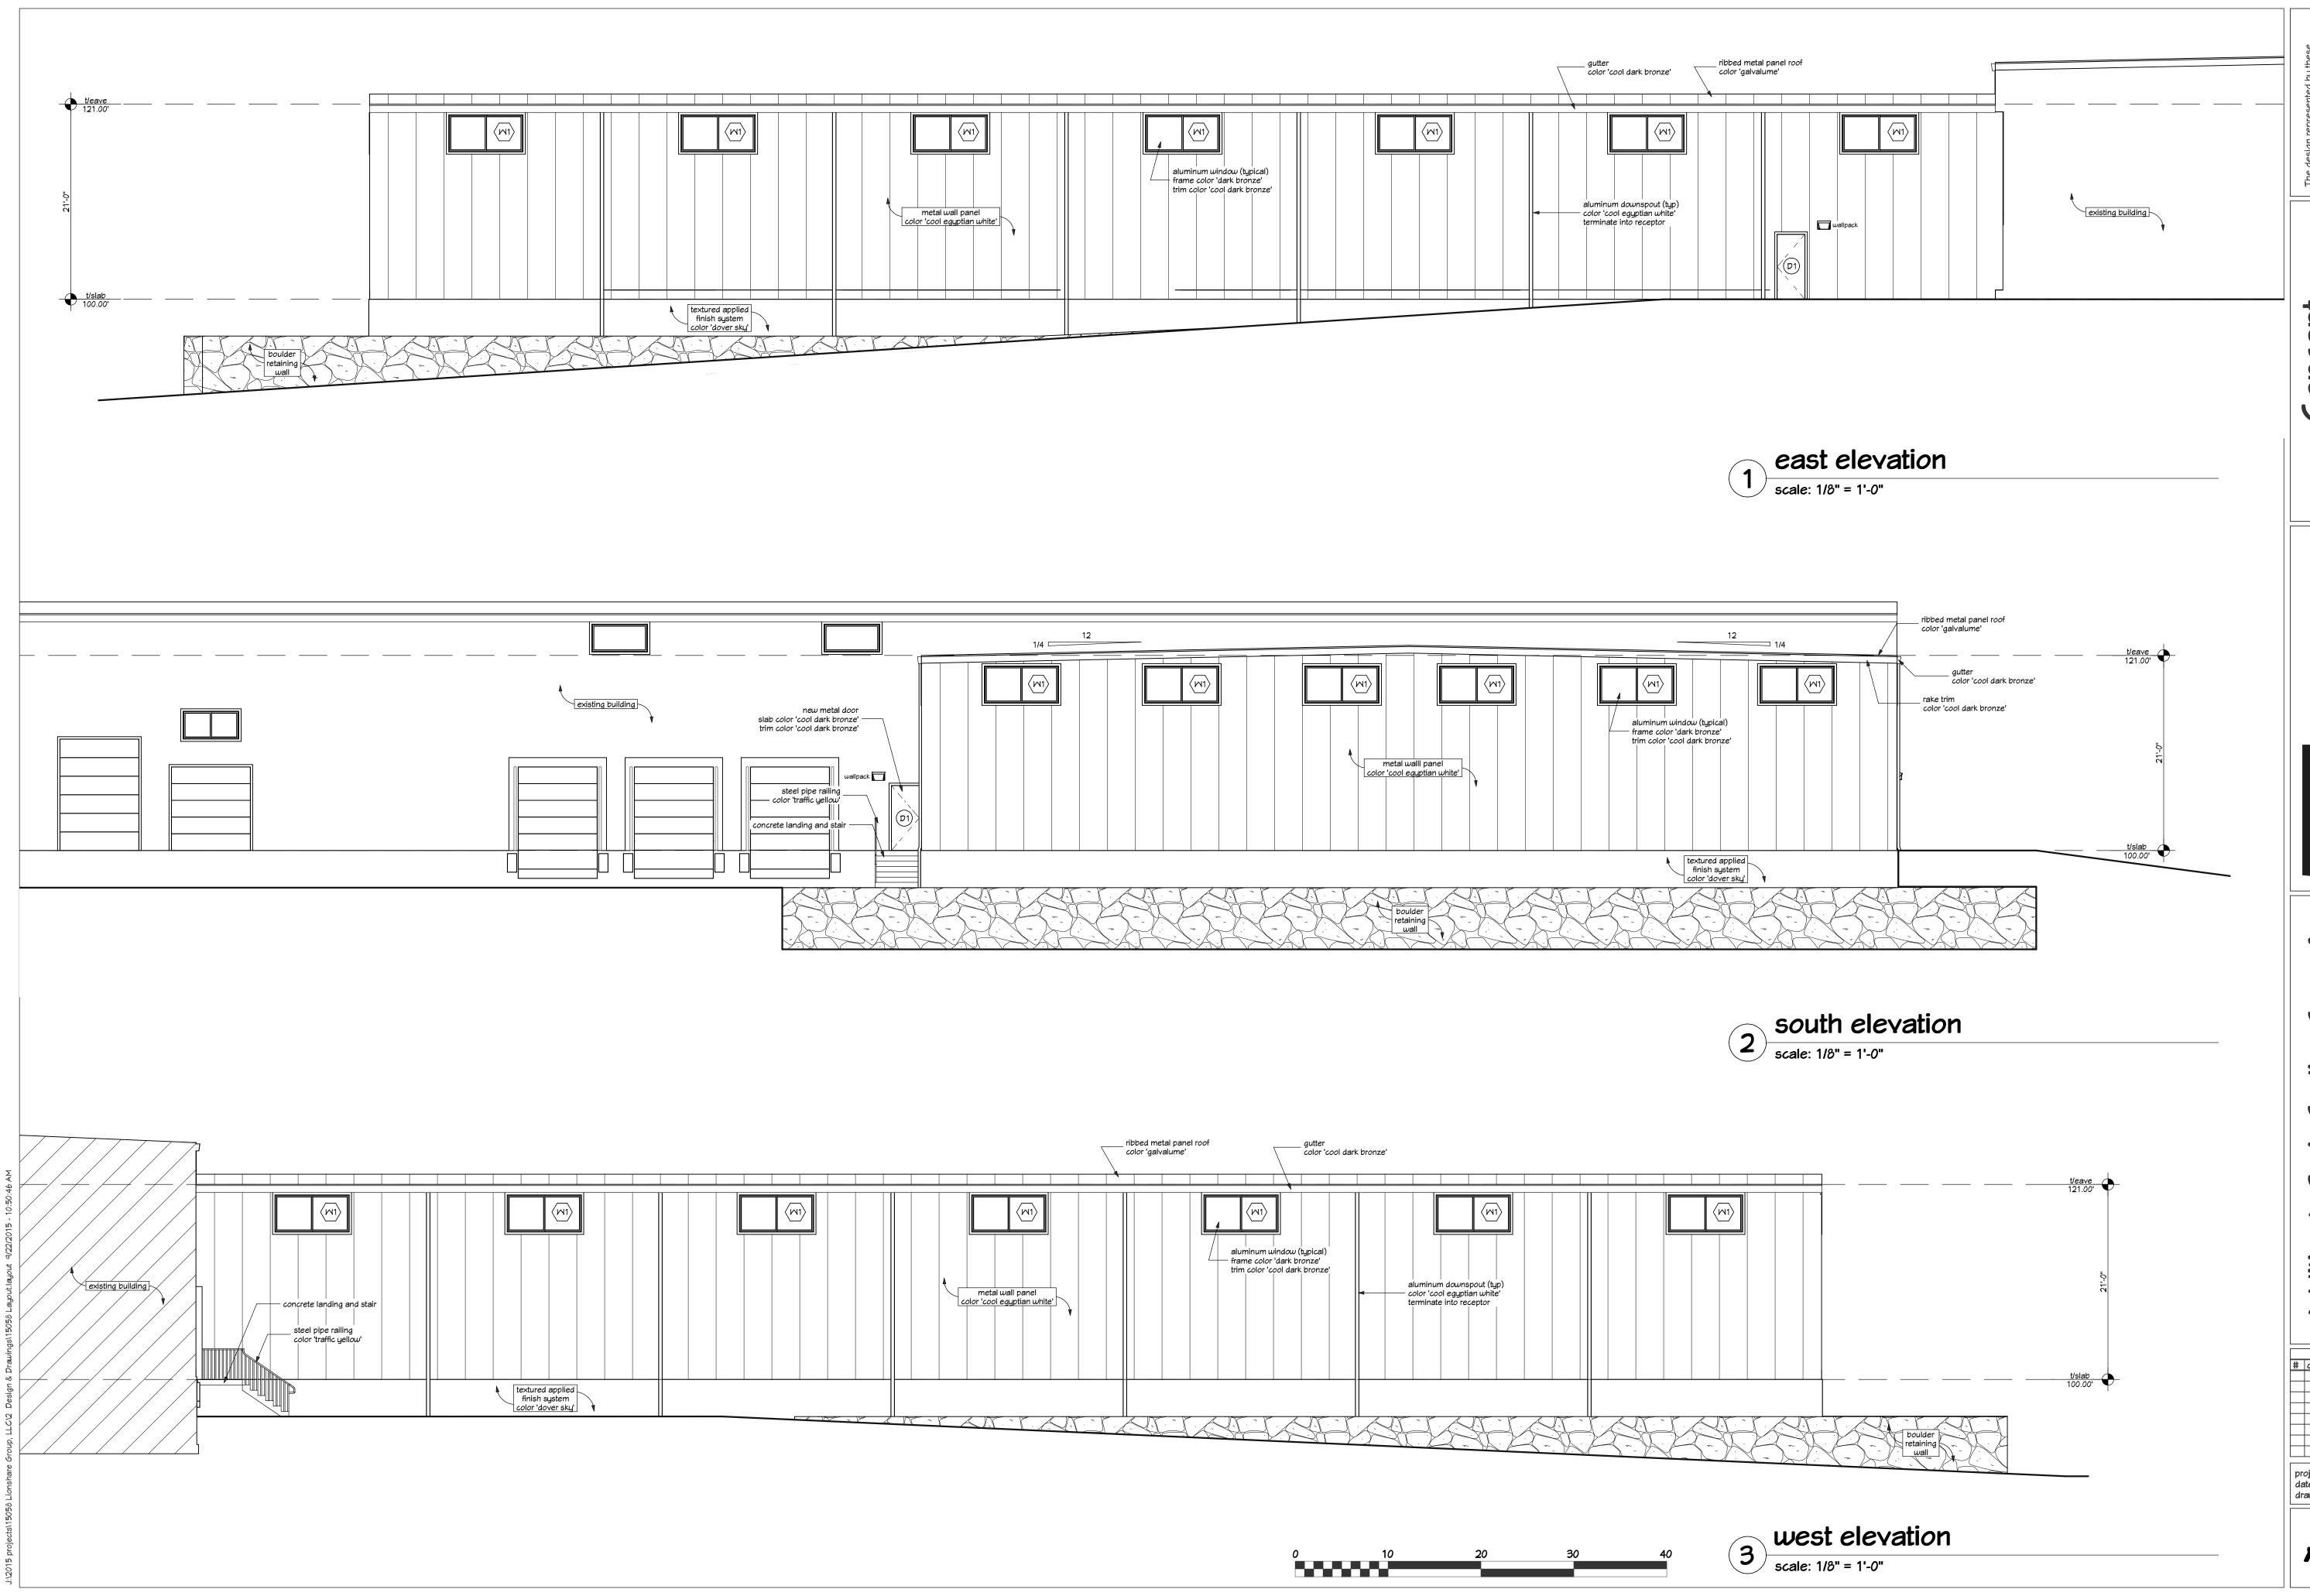
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project: 15058 date: 9/22/2015 drawn by: RLL